

P.O. Box 129, Manzanita, OR 97130-0129 Phone (503) 368-5343 Fax (503) 368-4145

### STAFF REPORT

- TO: Manzanita Planning Commission
- FROM: Walt Wendolowski, Contract Planner
- **SUBJECT:** Planning File Lot 13 Mixed-Use Design Review
- **DATE:** August 9, 2021

### I. BACKGROUND

- A. APPLICANT: Donnie Schmidt (for property owned by Sean and Melissa Pierce).
- B. PROPERTY LOCATION: Northside of Laneda Avenue, approximately 200-feet east of the intersection with North 5<sup>th</sup> Street. There is no site address and the County Assessor places the property within Township 3 North; Range 10 West; Section 29AC; Tax Lot #14800.
- C. PARCEL SIZE: The property contains 5,000 square feet.
- D. EXISTING DEVELOPMENT: The vacant lot fronts a public street and is served by public sewer and water.
- E. ZONING: The parcel is zoned Commercial (C-1).
- F. ADJACENT ZONING AND LAND USE: Property to the west, south and east is also zoned C-1 with City Hall located to the east and the remaining adjacent properties containing a mix of residences and commercial businesses. To the north are single family homes on property zoned High Density Residential/Limited Commercial (R-4).
- G. REQUEST: The applicant is requesting Design Review approval to construct a mixed-use commercial/residential building.
- H. DECISION CRITERIA: This application will be evaluated against the design review standards listed in Sections 4.080, 4.090 and 4.137 through 4.156 of Ordinance 95-4, and the standards for the Commercial (C-1) zone listed in Section 3.040 of Ordinance 95-4.

- I. SUBMITTED MATERIAL: In addition to the staff report, the application includes the following documents:
  - 1. Land Use Application
  - 2. Schematics and Plans Identified as "Progress Set"
  - 3. Schematics and Plans Identified as "Design Review and Architectural Drawings"
  - 4. E-Mail Comments Nehalem Bay Fire & Rescue

### II. APPLICATION SUMMARY

- A. The applicant wishes to construct a two-story, mixed-use building with a commercial ground floor and second floor apartment. The project will feature the following:
  - 1. The commercial ground floor will contain 1,200 square feet of area with an entrance facing Laneda Avenue. This front entrance will be landscaped with brick, include planters, trees and partially shaded by the second-floor balcony.
  - 2. The second floor, two-bedroom apartment contains 1,325 square feet of area with access is located on north side of the building. The north side of the site also includes five parking spaces, with three reserved for the commercial portion of the building.
  - 3. A shared driveway with the property to the west provides access to the site's parking. Landscaping improvements are located on the north, east and south sides of the building and include physical features such a paving along with new trees and shrubs.
  - 4. The building will have a wooden exterior finish with two varieties of lap siding. Each floor will be painted a different color. A composite, angled roof completes the structure.
- B. The City sent notice of this application to affected agencies. The Nehalem Bay Fire & Rescue noted there were no issues associated with the project. They also requested to be included in the final occupancy inspection upon completion. No other comments were submitted.
- C. Pursuant to Section 4.152.2, a Design Review is mandated for all new construction. This action is subject to a public hearing and review by the Planning Commission.

### III. CRITERIA AND FINDINGS – DESIGN REVIEW

A. As noted, the site is located within the C-1 zone. Development requirements for the C-1 zone are contained in Section 3.040, specifically in subsection "(3)".

Applicable items are noted below:

- 1. The proposed building meets the minimum setback requirements of 10feet for the front yard, and, 5-feet for the remaining yards.
- 2. The building does not exceed the maximum 28-feet 6-inch height limitation of the zone.
- 3. At least 10% of the 5,000 square foot site must be landscaped, or a minimum of 500 square feet. The site plan identifies 1,130 square feet of landscaping improvements, of which 630 square feet contain living plant material.
- 4. Signs, awnings, marquees and sidewalk coverings shall extend not more than 10 feet from a building or more than 5 feet over a sidewalk, whichever is less. The second-floor balcony extends 6-feet from the building and does not encroach upon the Laneda Avenue sidewalk.
- 5. Dry wells and/or under pavement catch-and-release system will be provided as determined by the city and engineering considerations to address drainage.
- 6. A design review is required which is addressed in the following sections of this report.
- 7. The Floor Area Ratio of this project is 0.34 and including all structures on the property. This ratio does not exceed the 0.65 limit for the C-1 zone.
- 8. Signs must conform to Ordinance requirements. This will be addressed as a separate permit.

Based on the above findings, the building conforms to the development provisions of the C-1 zone.

B. Sections 4.080 establishes the City's parking requirements. It specifically notes that "(A)t the time a new structure is erected or the use of an existing structure is changed or enlarged, off-street parking spaces, loading areas and access thereto shall be provided as set forth in this section unless greater requirements are otherwise established."

FINDINGS: As a new structure, parking is required. All required spaces will be on the same lot and be accessed by a private driveway. The identified spaces meet the minimum 9-foot by 18-foot space requirement. The commercial parking area effectively doubles as a delivery area which, for most smaller retail spaces, is common and sufficient. Access will be shared with the adjacent parcel; evidence of a shared agreement will be required. The proposal complies with provisions in this Section.

C. Sections 4.090 establishes the City's parking standards.

FINDINGS: Per 4.090.3(b), for Commercial zoned lots of no more than 5,000 square feet in size, one space is required for a single residence. In addition, the 1,200 square foot commercial space requires one space per 400 square feet of

area [Section 4.090.3(f)] for a total of three spaces. The layout includes three commercial spaces, one residential space and a shared ADA space. The proposal meets the parking space requirement.

D. Provisions in Sections 4.137 to 4.142 address site plan reviews (4.137), the use of fill for structural elevation (4.138), parking structures in the front yard (4.141) and matters regarding trees (4.142).

FINDINGS: This application and process are consistent with provisions in Section 4.137 which describe the submittal requirements. While site grading is necessary, fill is not required to construct the building (Section 4.138). As noted, all parking will be located on the north side of property while the front yard, in turn, will be appropriately landscaped (Section 4.141). The 15 existing trees on the site will be removed and replaced by additional native trees along the perimeter (Section 4.142).

E. Section 4.150 identifies the purpose of the design review process:

"The purpose of Sections 4.150 through 4.158 is to provide design standards for commercial and mixed-use development in Manzanita's commercial zones and in the High Density Residential/Limited Commercial zone. Design review provides aesthetic judgment over development projects in order to maintain the unique character of the community by keeping buildings to human scale and reflecting the natural beauty of the city's setting, to encourage the traditional style of the Pacific Northwest, and to protect the viability of the commercial zones. The standards provide for originality, flexibility and innovation in site planning and development and encourage development where structures, use areas, artistic expression and site elements are integrated in a manner that is harmonious within the site and with adjacent properties. Design review criteria shall be applicable to all new construction, alteration of site improvements, or exterior alteration of commercial and mixed-use development in the C-1, LC, and R-4 zones."

FINDINGS: Section 4.150 seeks to determine whether the proposal maintains the unique characteristics of the community. The exterior will be finished with shiplap siding on the ground floor and lap siding on the second floor. Trim, such as the entrance screening or the balcony, will also feature a wooden finish. The color combination of a dark brown second floor and light tan ground floor complements the trees in the vicinity. Further the design is somewhat similar to the commercial buildings located on the corner of Laneda and 5<sup>th</sup>. On balance, while the design is original, it generally fits into the area and certainly does not offer a jarring contrast to other structures in the vicinity.

F. Section 4.151 lists applicable definitions while Section 4.152 identifies when a design review is required. The definitions are applicable to the design review process but do not by themselves establish design criteria (Section 4.151).

Finally, as previously noted, a design review is required as the proposal involves the construction of a new building (Section 4.152).

- G. Section 4.153 outlines the review procedures. For the purpose of this Section, a pre-application conference occurred and the applicant submitted the required material. Further, the City mailed notice to area property owners in compliance with applicable provisions.
- H. Section 4.154 outlines the purpose behind the design review criteria. This Section states "(*T*)he design review criteria are intended to provide a frame of reference for the applicant in the development of site, building and landscape plans and to provide the city with a means of reviewing proposed plans. These criteria are not intended to be inflexible requirements nor are they intended to discourage creativity or innovation. The criteria do not intend to specify a particular architectural style." Further: "(*T*)he Design Review Board is not authorized to approve projects which do not adhere to specific development standards provided by this ordinance (e.g., building height or setbacks.)"
- I. Section 4.155 contains the specific decision criteria; each item is reviewed below:
  - 1. In terms of setback from street or sidewalk, the design creates a visually interesting and compatible relationship between the proposed structure and the surrounding area.

FINDINGS: The structure will be setback 10-feet from the front property line, complying with the setback requirement. This area provides an entrance to commercial portion of the building and includes paving stones and planters containing four trees. With the overhead balcony, the area has potential for outdoor seating. Generally, the space complements the building style and proposed finish.

2. The design incorporates existing features such as rocks, slopes and vegetation.

FINDINGS: As the site will be cleared to accommodate the new structure and parking, not all of the existing vegetation could be retained. However, this will be supplanted with new tree and shrub plantings on the perimeter of the site.

3. Where appropriate, the design relates or integrates the proposed landscaping/open space to the adjoining space in order to create pedestrian pathways and/or open system that connects other properties.

FINDINGS: The three commercial buildings to the west, and the former City Hall property to the east include open spaces for pedestrians along the Laneda Avenue frontage. The proposed building's front yard design is similar to these structures, thereby enhancing this portion of the street.

4. The design gives attention to the placement of storage or mechanical equipment so as to screen it from view.

FINDINGS: Based on submitted drawings, the roof does not contain any mechanical equipment. The HVAC equipment will be located on the northeast corner of the building and sharing space with the waste/recycling equipment behind an enclosure.

5. All functions, uses and improvements are arranged to reflect and harmonize with the natural characteristics and limitations of the site and adjacent properties.

FINDINGS: As noted, the building is generally consistent in finish, color and style with a majority of the buildings in the vicinity and completements the trees within the vicinity.

- J. Section 4.156 contains the decision criteria evaluating architectural and landscaping design; each item is reviewed below:
  - 1. The design integrates and harmonizes the existing and proposed development with the existing surroundings and future allowed uses. This standard shall be applied in a manner that encourages village design and visual diversity within development projects and the surrounding area. Corrugated siding is prohibited as it does not harmonize with siding used on most existing buildings.

FINDINGS: The building is generally consistent in finish, color and style with a majority of the buildings in the vicinity. The structure utilizes a wooden exterior – as are many adjacent structures - and does not include the use of corrugated siding or similar metal finishes.

2. The landscape design acknowledges the growing conditions for the climatic zone, and provisions are made for the survival and continuous maintenance. The landscape design shall include the use of local native species of trees and shrubs.

FINDINGS: Based on submitted comments and plans, an in-ground water system will serve the vegetative improvements.

3. The minimum lot area required to be landscaped under Section 3.040(3)(d) for commercial, mixed use, or non-residential uses shall be located in the front and side yards and the portion of the lot adjacent to the front or street side yards and not within the foundation footprint or rear yard. Living plant material shall cover at least 50% of this required minimum landscape area. For corner lots, at least 25% of the living plant

material required by this section shall face each street frontage.

FINDINGS: As noted, above, only 500 square feet of landscaping is required, of which 50% or 250 square feet must be in living plant material. The site contains 1,130 of landscaping of which 630 square feet are in living plan material.

- 4. [Reserved]
- 5. The grading and contouring of the site, and on-site drainage facilities, shall be designed so there is no adverse effect on neighboring properties or public rights-of-way.

FINDINGS: While downspouts were identified on the plans, submitted building and/or engineering plans will need to show an approved point of discharge for any storm water generated by the development.

6. The design avoids monotony and provides visual interest by giving sufficient attention to architectural details and to design elements.

FINDINGS: Each floor has a different, but compatible, color scheme. This is further enhanced by different types of siding, wooden trim and the placement and size of windows. On balance, these provide a visual interest to the structure.

7. The design adequately addresses the pedestrian nature of the commercial area and places structures in relation to sidewalks and open areas to foster human interaction.

FINDINGS: The front setback and balcony overhang offers an open space area that can be used for outdoor seating thereby improving interaction with pedestrians.

8. Lighting is non-industrial and non-invasive in character, and contributes to the village character.

FINDINGS: Plans and schematics for the structure placed the lighting primarily at the doorway entrances. A lighting plan is submitted as part of the building plans to ensure lighting is not directed onto adjacent properties.

- 9. Compatibility. All new commercial and mixed-use buildings and exterior alterations shall be designed consistent with the architectural context in which they are located. This standard is met when the Design Review Board finds that all of the criteria in a.- c., below, are met.
  - a. There is compatibility in building sizes between new and existing

commercial and mixed use buildings;

- b. The size, shape and scale of the structures are architecturally compatible with the site and with the village character of the surrounding neighborhood. Particular attention will be paid to addressing the visual impact of the structures on residential uses that are adjacent or on the opposite side of the same street.
- c. All buildings and developments shall provide human scale design. The design avoids a monolithic expanse of frontages and roof lines, diminishes the massing of buildings by breaking up building sections, and/or by use of such elements as visual planes, projections, bays, dormers, second floor setbacks or changes in the roof line, and/or similar features generally shown in the following figure (see Ordinance). Changes in paint color and features that are not designed as permanent architectural elements, such as display cabinets, window boxes, retractable and similar mounted awnings or canopies, and other similar features will not independently satisfy this criterion.

FINDINGS: This report previously reviewed the compatibility with area properties (items a., and b.). While not an architectural "match" with surrounding structures, the design and finish are generally compatible with these structures. The two separate floors have different exterior finishes and the second floor has a balcony overhang on the ground floor. In combination with the relatively large expanse of windows on the first floor, the design avoids creating a single monolithic structure. On balance, staff finds the improvement consistent with the intent of the design standards.

K. Section 4.158 includes on performance assurance, including building permit requirements and time limitations.

FINDINGS: These are administrative requirements applicable to both the City and applicant.

### IV. RECOMMENDATION AND CONDITIONS OF APPROVAL

City staff finds the proposal complies with the applicable Design Review criteria and recommends the Planning Commission approve the application subject to the following Conditions:

A. The developer shall submit engineering plans to the City of Manzanita addressing water, storm water, street improvements and similar private facility improvements. Sanitary sewer plans shall also be submitted the Nehalem Bay Wastewater Agency (NBWA). These plans shall be reviewed and approved by the City and NBWA prior to construction.

- B. The developer shall submit a building permit for construction of the mixed-use building, conforming to the applicable building code requirements. The submitted site plan shall substantially conform to the approved layout. While building plans may be simultaneously submitted with engineering plans, building permits shall not be issued until all engineering plans are reviewed and approved.
- C. Prior to receiving a building permit, the developer shall submit evidence of a shared access agreement that includes the adjacent property to the west.
- D. Prior to occupancy, the developer shall complete the following:
  - 1. Install and/or extend public facility improvements, consistent with City and/or NBWA approved engineering plans.
  - 2. Install parking improvements consistent with approved building and engineering plans.
- E. The structure shall comply with the building permit requirements and conform to the submitted site plan. The applicant is advised that modifications to the approved plan may require a new design review application and decision.
- F. Compliance with these conditions, the requirements of the Manzanita Zoning Ordinance, Nehalem Bay Wastewater Agency, Nehalem Bay Fire & Rescue and applicable building code provisions shall be the sole responsibility of the developer.


### V. PLANNING COMMISSION ACTION

- A. The Planning Commission has the following options:
  - 1. Approve the application, adopting findings and conditions contained in the staff report;
  - 2. Approve the application, adopting modified findings and/or conditions;
  - 3. Deny the application, establishing findings as to why the application fails to comply with the decision criteria.
- B. Staff will prepare a document for the Chair's signature.

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1) Structural Grid Line	<b>EXECUTIVE ARCHITECT</b> METHOD DESIGN 5392 TREE ST, LAKE OSWEGO, OR 97035	
Smoke Alarm Indicator	(323) 337-6967 STRUCTURAL ENGINEERING TBD	
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SCALE: NTS	SCALE: NTS 5	
OK COUNTY / CITY OF MANZANITA GON STRUCTURAL SPECIALTY CODE MERCIAL	ENERGY EFFICIENCY / PERSCRIPTIVE ENVELOPE REQUIREMENTS PER TABLE C402.1.3         ALL CONDITIONED SPACES W/IN BUILDING SHALL COMPLY AS FOLLOWS:         CLIMATE ZONE:       ZONE 5 / MARINE (ZONE 4 ADJUSTED)         C1       GROUP R	
10 FT 5 FT 30 FT	ROOFSINSULATION ABOVE ROOF DECKR30ciMETAL BUILDINGSR19+R11LSATTIC AND OTHERR38MASSR11.4ci	
	WALLS, ABOVE GRADEMASSR11.4ciR13.3ciMETAL BUILDINGR13+R13ciR13+R13ciMETAL FRAMEDR13+R7.5ciR13+R7.5ciWOOD FRAMEDR20R20+R3.8ci	CAN NO
	WALLS, BELOW GRADE       BELOW GRADE WALL       R7.5ci	
	FLOORSMASSR10ciJOIST / FRAMINGR30R30	
	SLAB ON GRADE FLOORSUNHEATED SLABSR10 for 24" belowHEATED SLABSR15 for 36" below + R5 full slab	
	OPAQUE DOORSNONSWINGINGR4.75SWINGING DOORU0.37GARAGE DOOR <14% GLAZING	
IG CODE INFORMATION SCALE: NTS 7	ENERGY EFFICIENCY CODE 4	

	ITIAL DESIGN DRAWING SHEETS	SUB 01	
.000	DATA SHEET		
.001	GENERAL NOTES		
.010	DIAGRAMS		
.020	SCHEDULES: DOORS AND HARDWARE		
.021	SCHEDULES: WINDOWS		
.022	SCHEDULES: MATERIALS		
.023	SCHEDULES: PLMB / APPLICANCE / EQPMT / LIGHTING		
100	SITE PLAN		
.101	SITE PLAN: HUB AND TACK		
201	FLOOR PLAN: COMMERCIAL MAIN LEVEL	•	
.202	FLOOR PLAN: RESIDENTIAL UPPER LEVEL		
203	FLOOR PLAN: ROOF LEVEL		
.241	REFLECTED CEILING PLAN: MAIN LEVEL		
.242	REFLECTED CEILING PLAN: MAIN LEVEL		
.300	EXTERIOR ELEVATIONS: WEST / SOUTH		
.301	EXTERIOR ELEVATIONS: EAST / NORTH		
400	BLDG SECTION		
.700	INTERIOR ELEVATIONS		
.800	DETAILS		
TRUCTL	JRAL DRAWING SHEETS		
0.1	COVER SHEET / GENERAL NOTES		
<u></u> 1.1	FRAMING PLAN: FOUNDATION AND FIRST FLOOR		
1.2	FRAMING PLAN: ROOF		
3.1	STRUCTURAL DETAILS		
3.2	STRUCTURAL DETAILS		
<u>3.2</u> 3.3	STRUCTURAL DETAILS		
0.0			



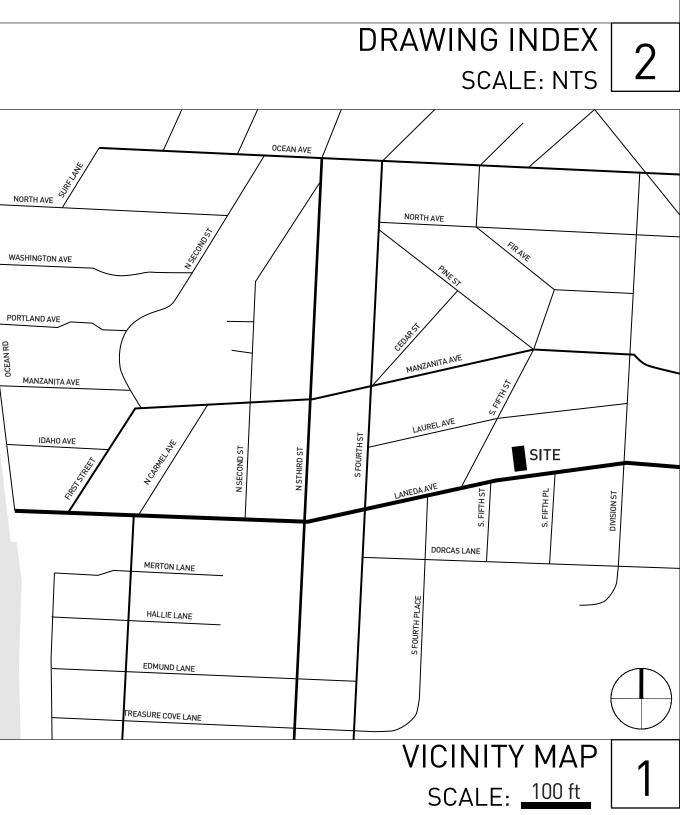

CENTERFIELD STUDIO, LLC 5392 TREE ST, LAKE OSWEGO OR, 97035 T:323.337.6967 / CENTERFIELDSTUDIO.COM

EXECUTIVE ARCHITECT:



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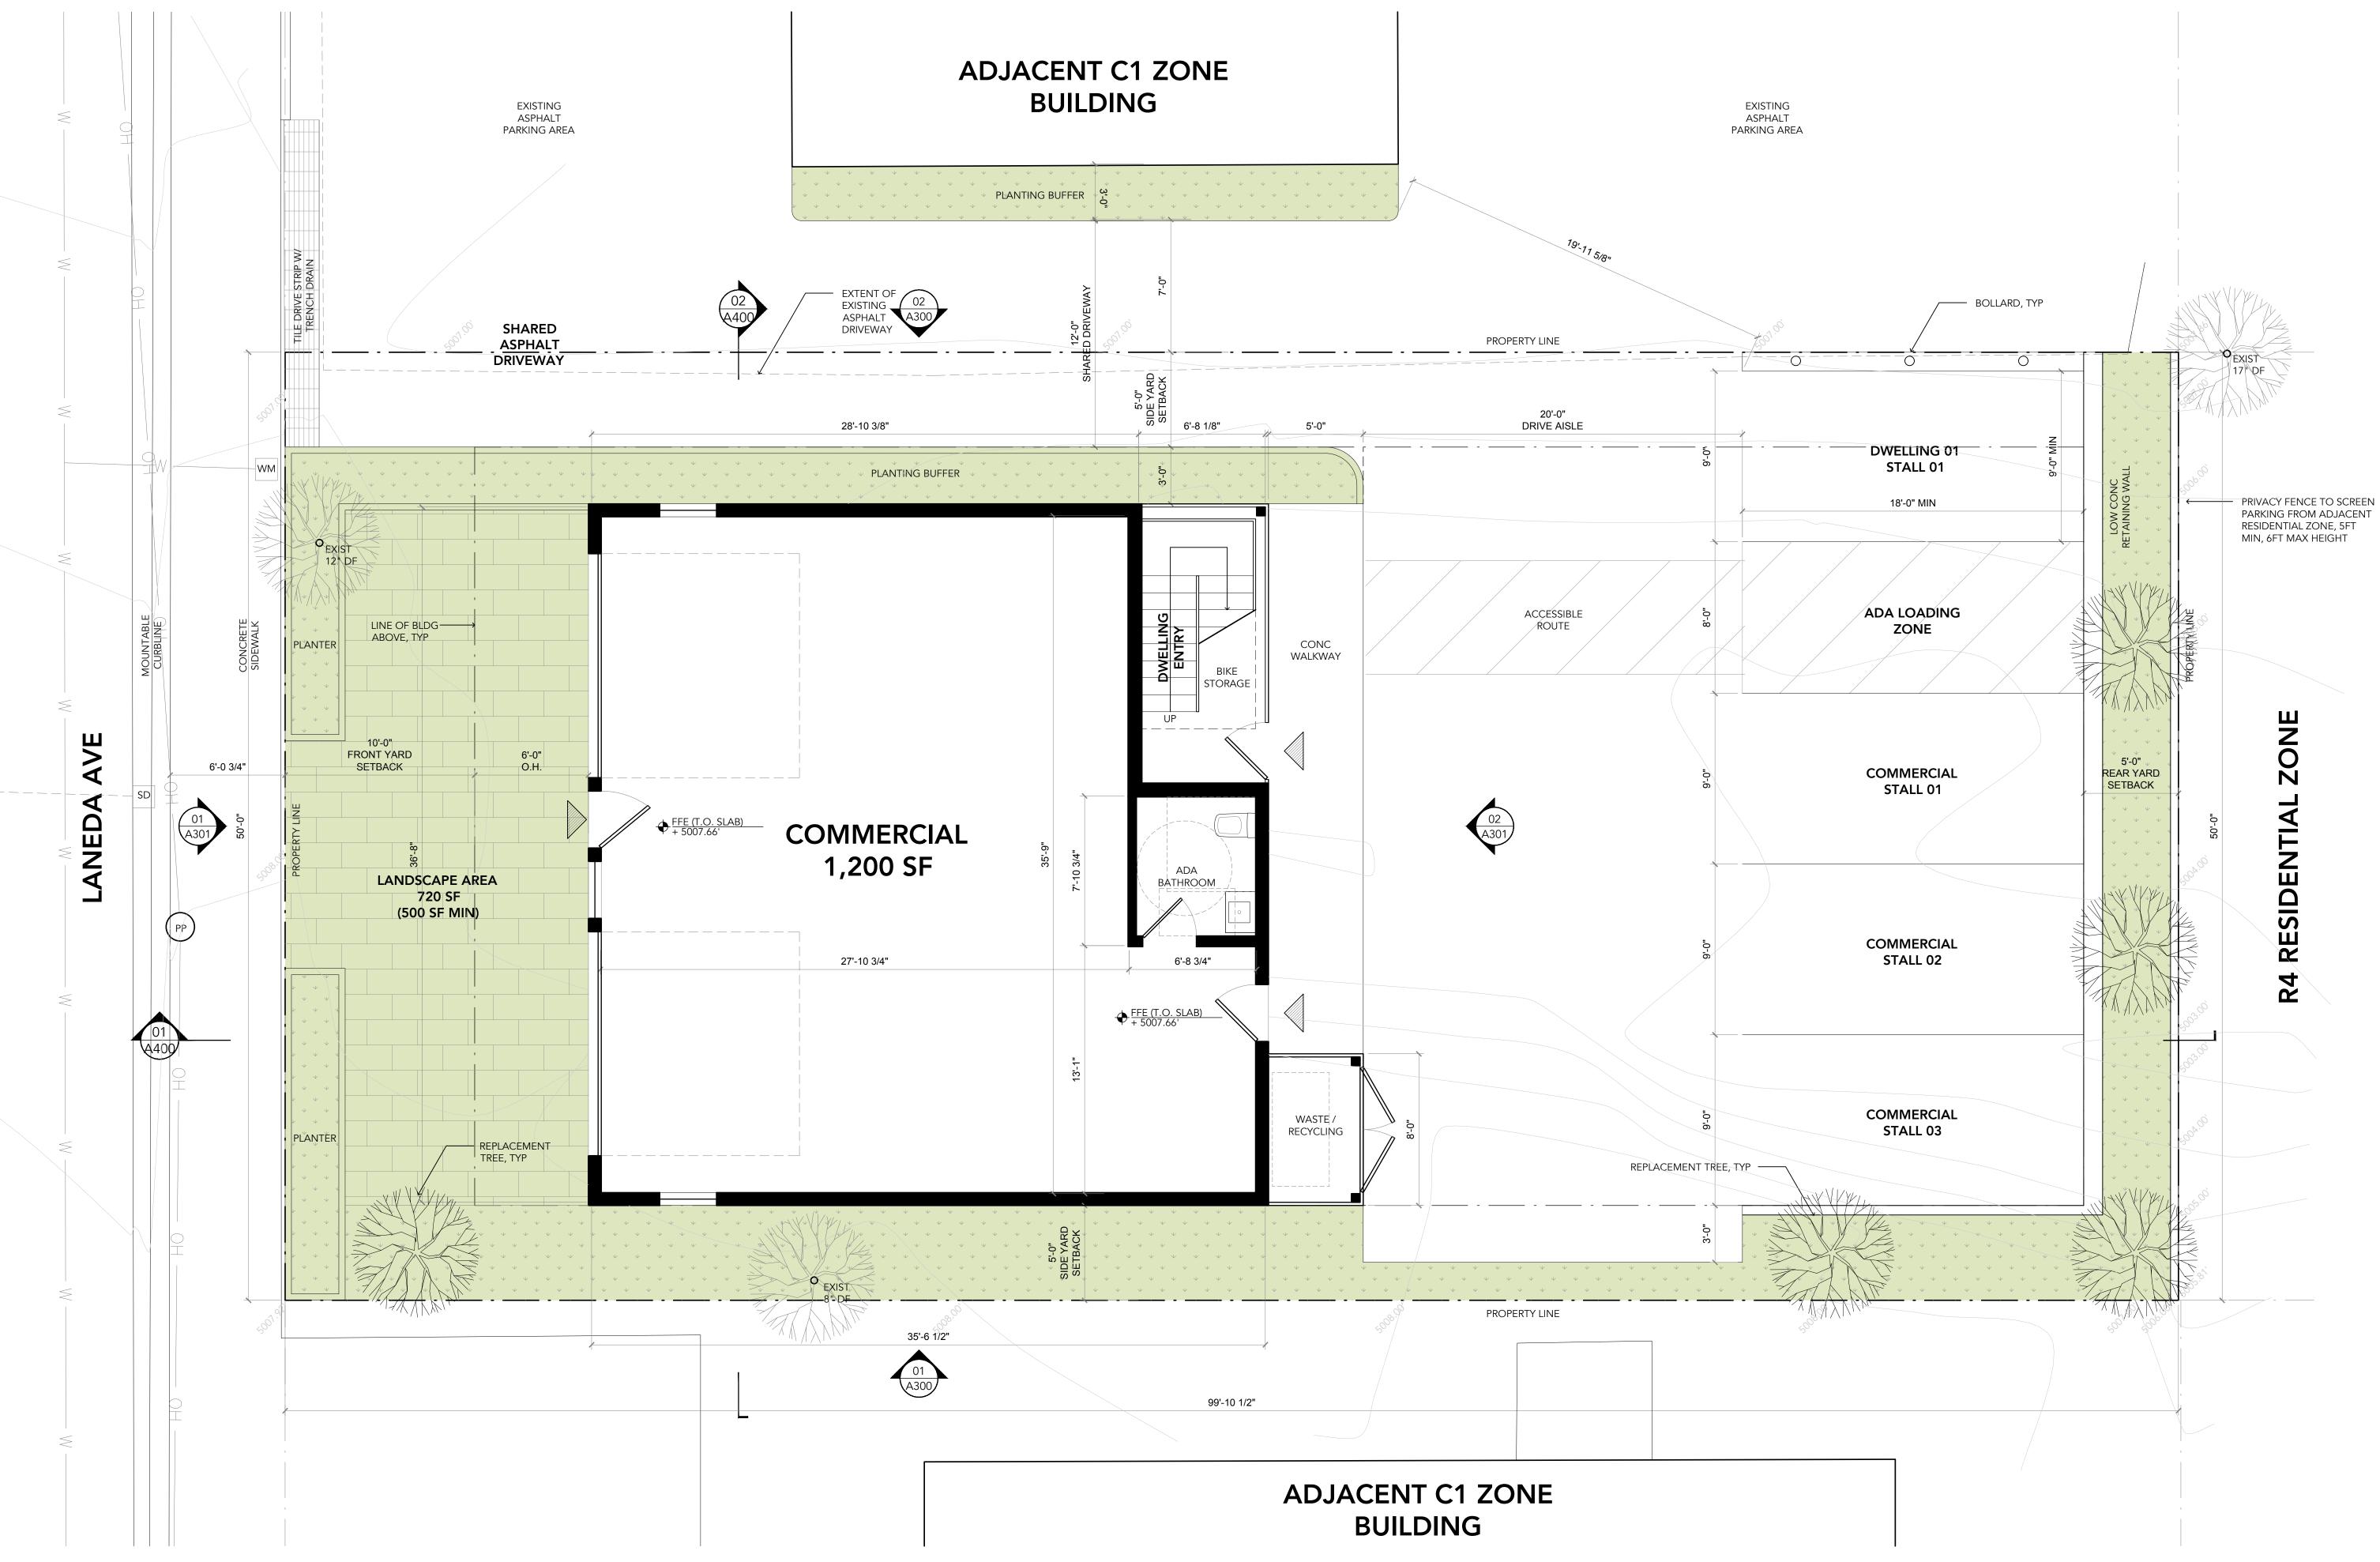
## LOT 13 LANEDA MIXED-USE LOT 13 LANEDA AVE MANZANITA, OR 97130

DATE JUNE 15, 2021

PHASE DESIGN DEVELOPMENT

REVISION NO / DATE





FLOOR PLAN: MAIN LEVEL (COMMERCIAL)

LEAD DESIGNER:



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LOT 13 LANEDA MIXED-USE LOT 13 LANEDA AVE MANZANITA, OR 97130


DATE JUNE 15, 2021

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SCALE: 1/4"



FLOOR PLAN: UPPER LEVEL (RESIDENTIAL) SCALE: 1/4" LEAD DESIGNER:

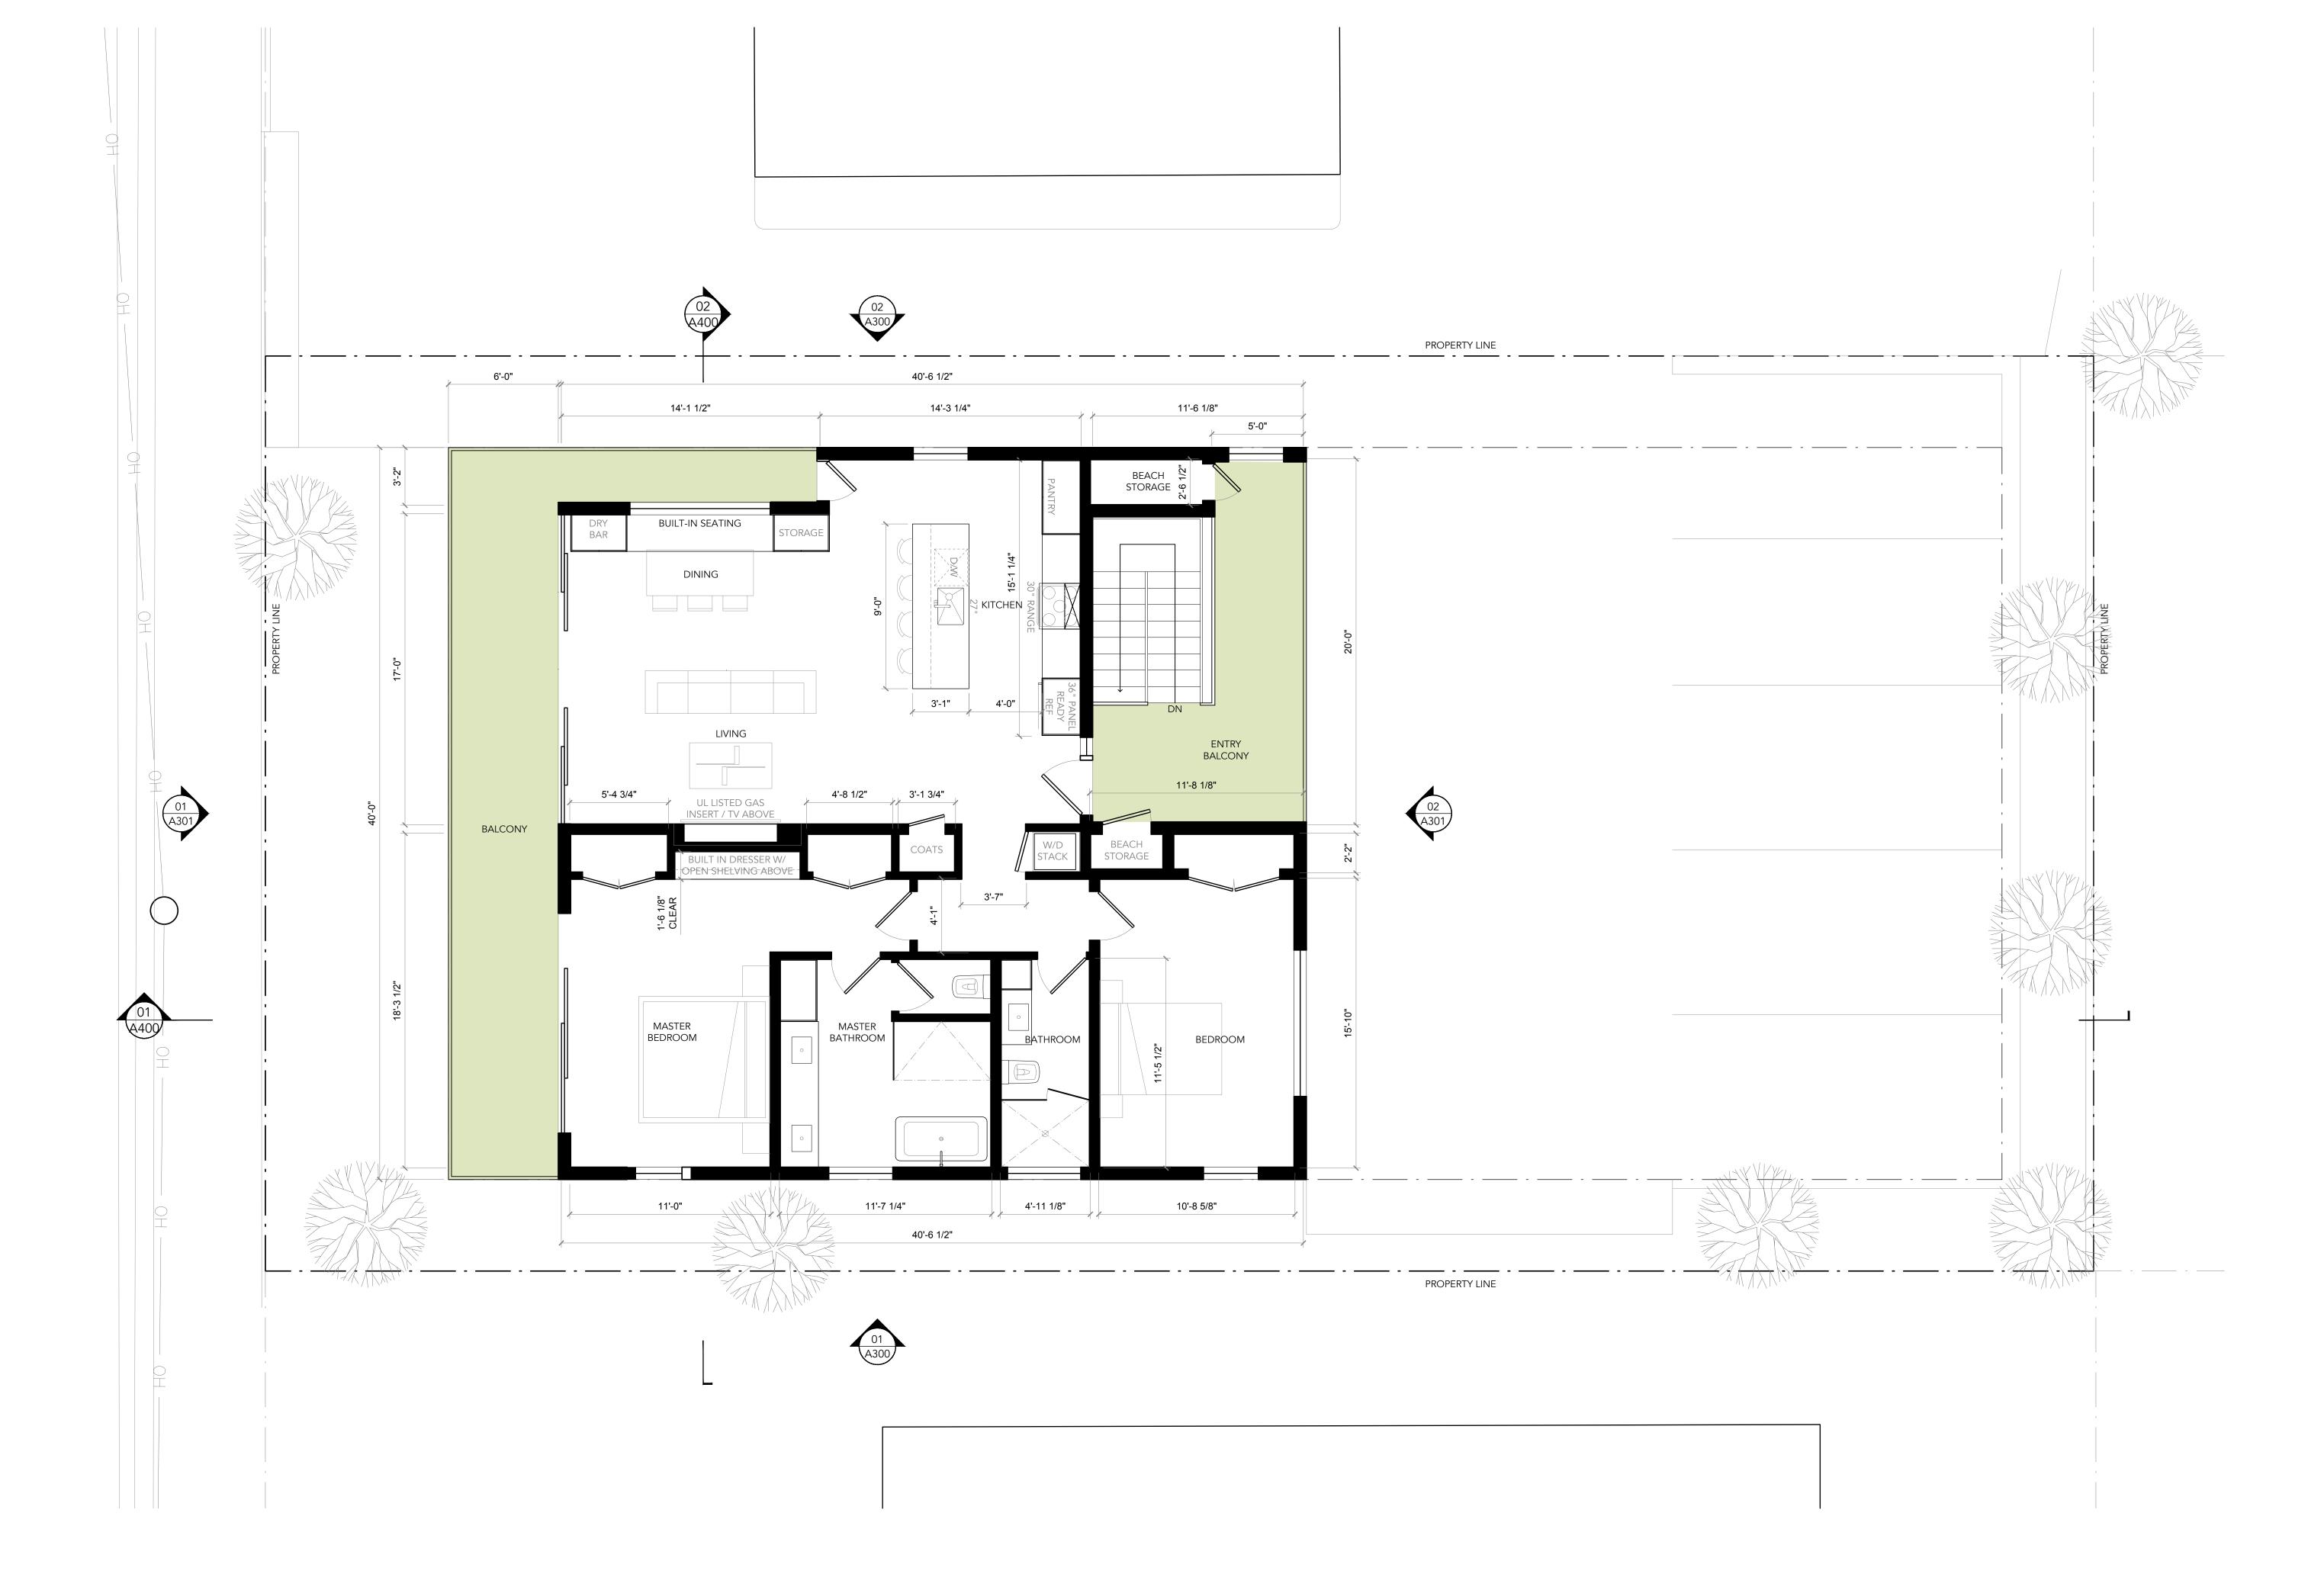

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EXECUTIVE ARCHITECT:




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LOT 13 LANEDA MIXED-USE LOT 13 LANEDA AVE MANZANITA, OR 97130

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LOT 13 LANEDA MIXED-USE LOT 13 LANEDA AVE MANZANITA, OR 97130

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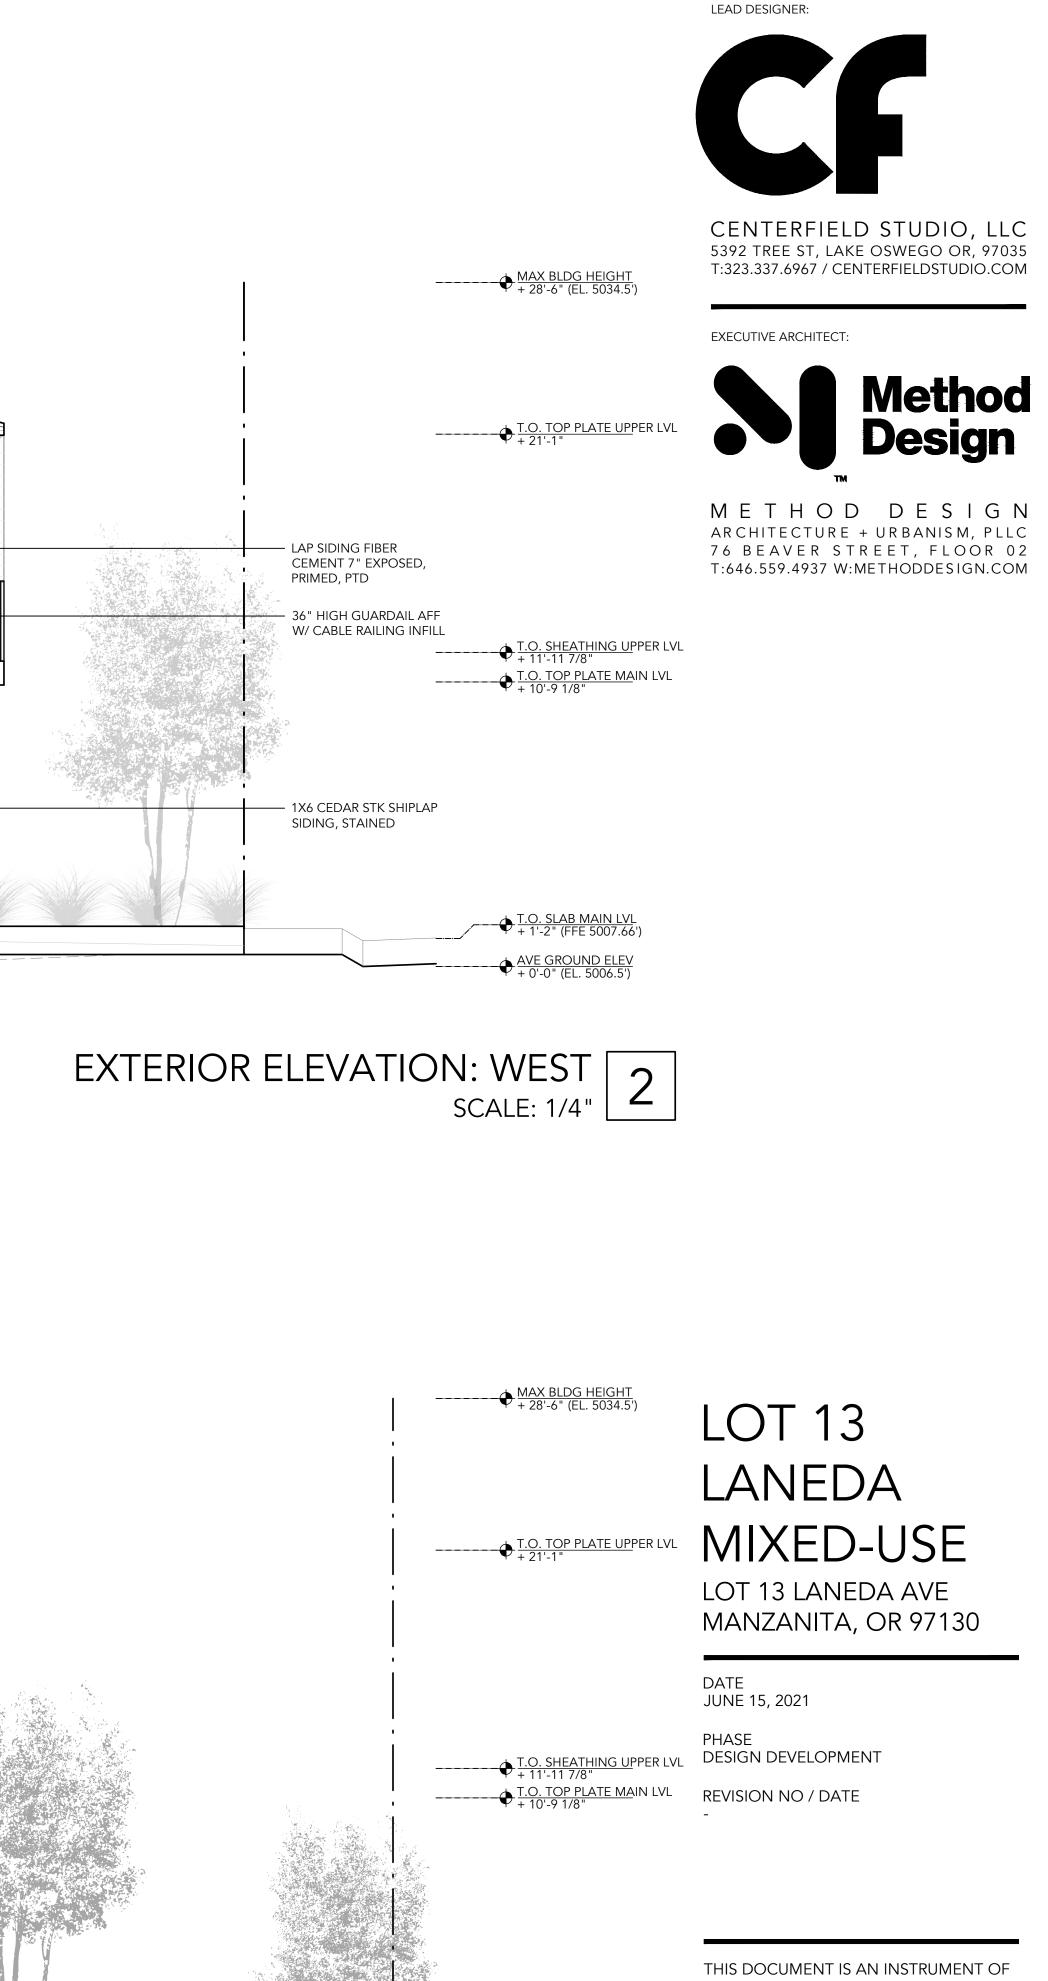
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ROOF PLAN SCALE: 1/4" 1





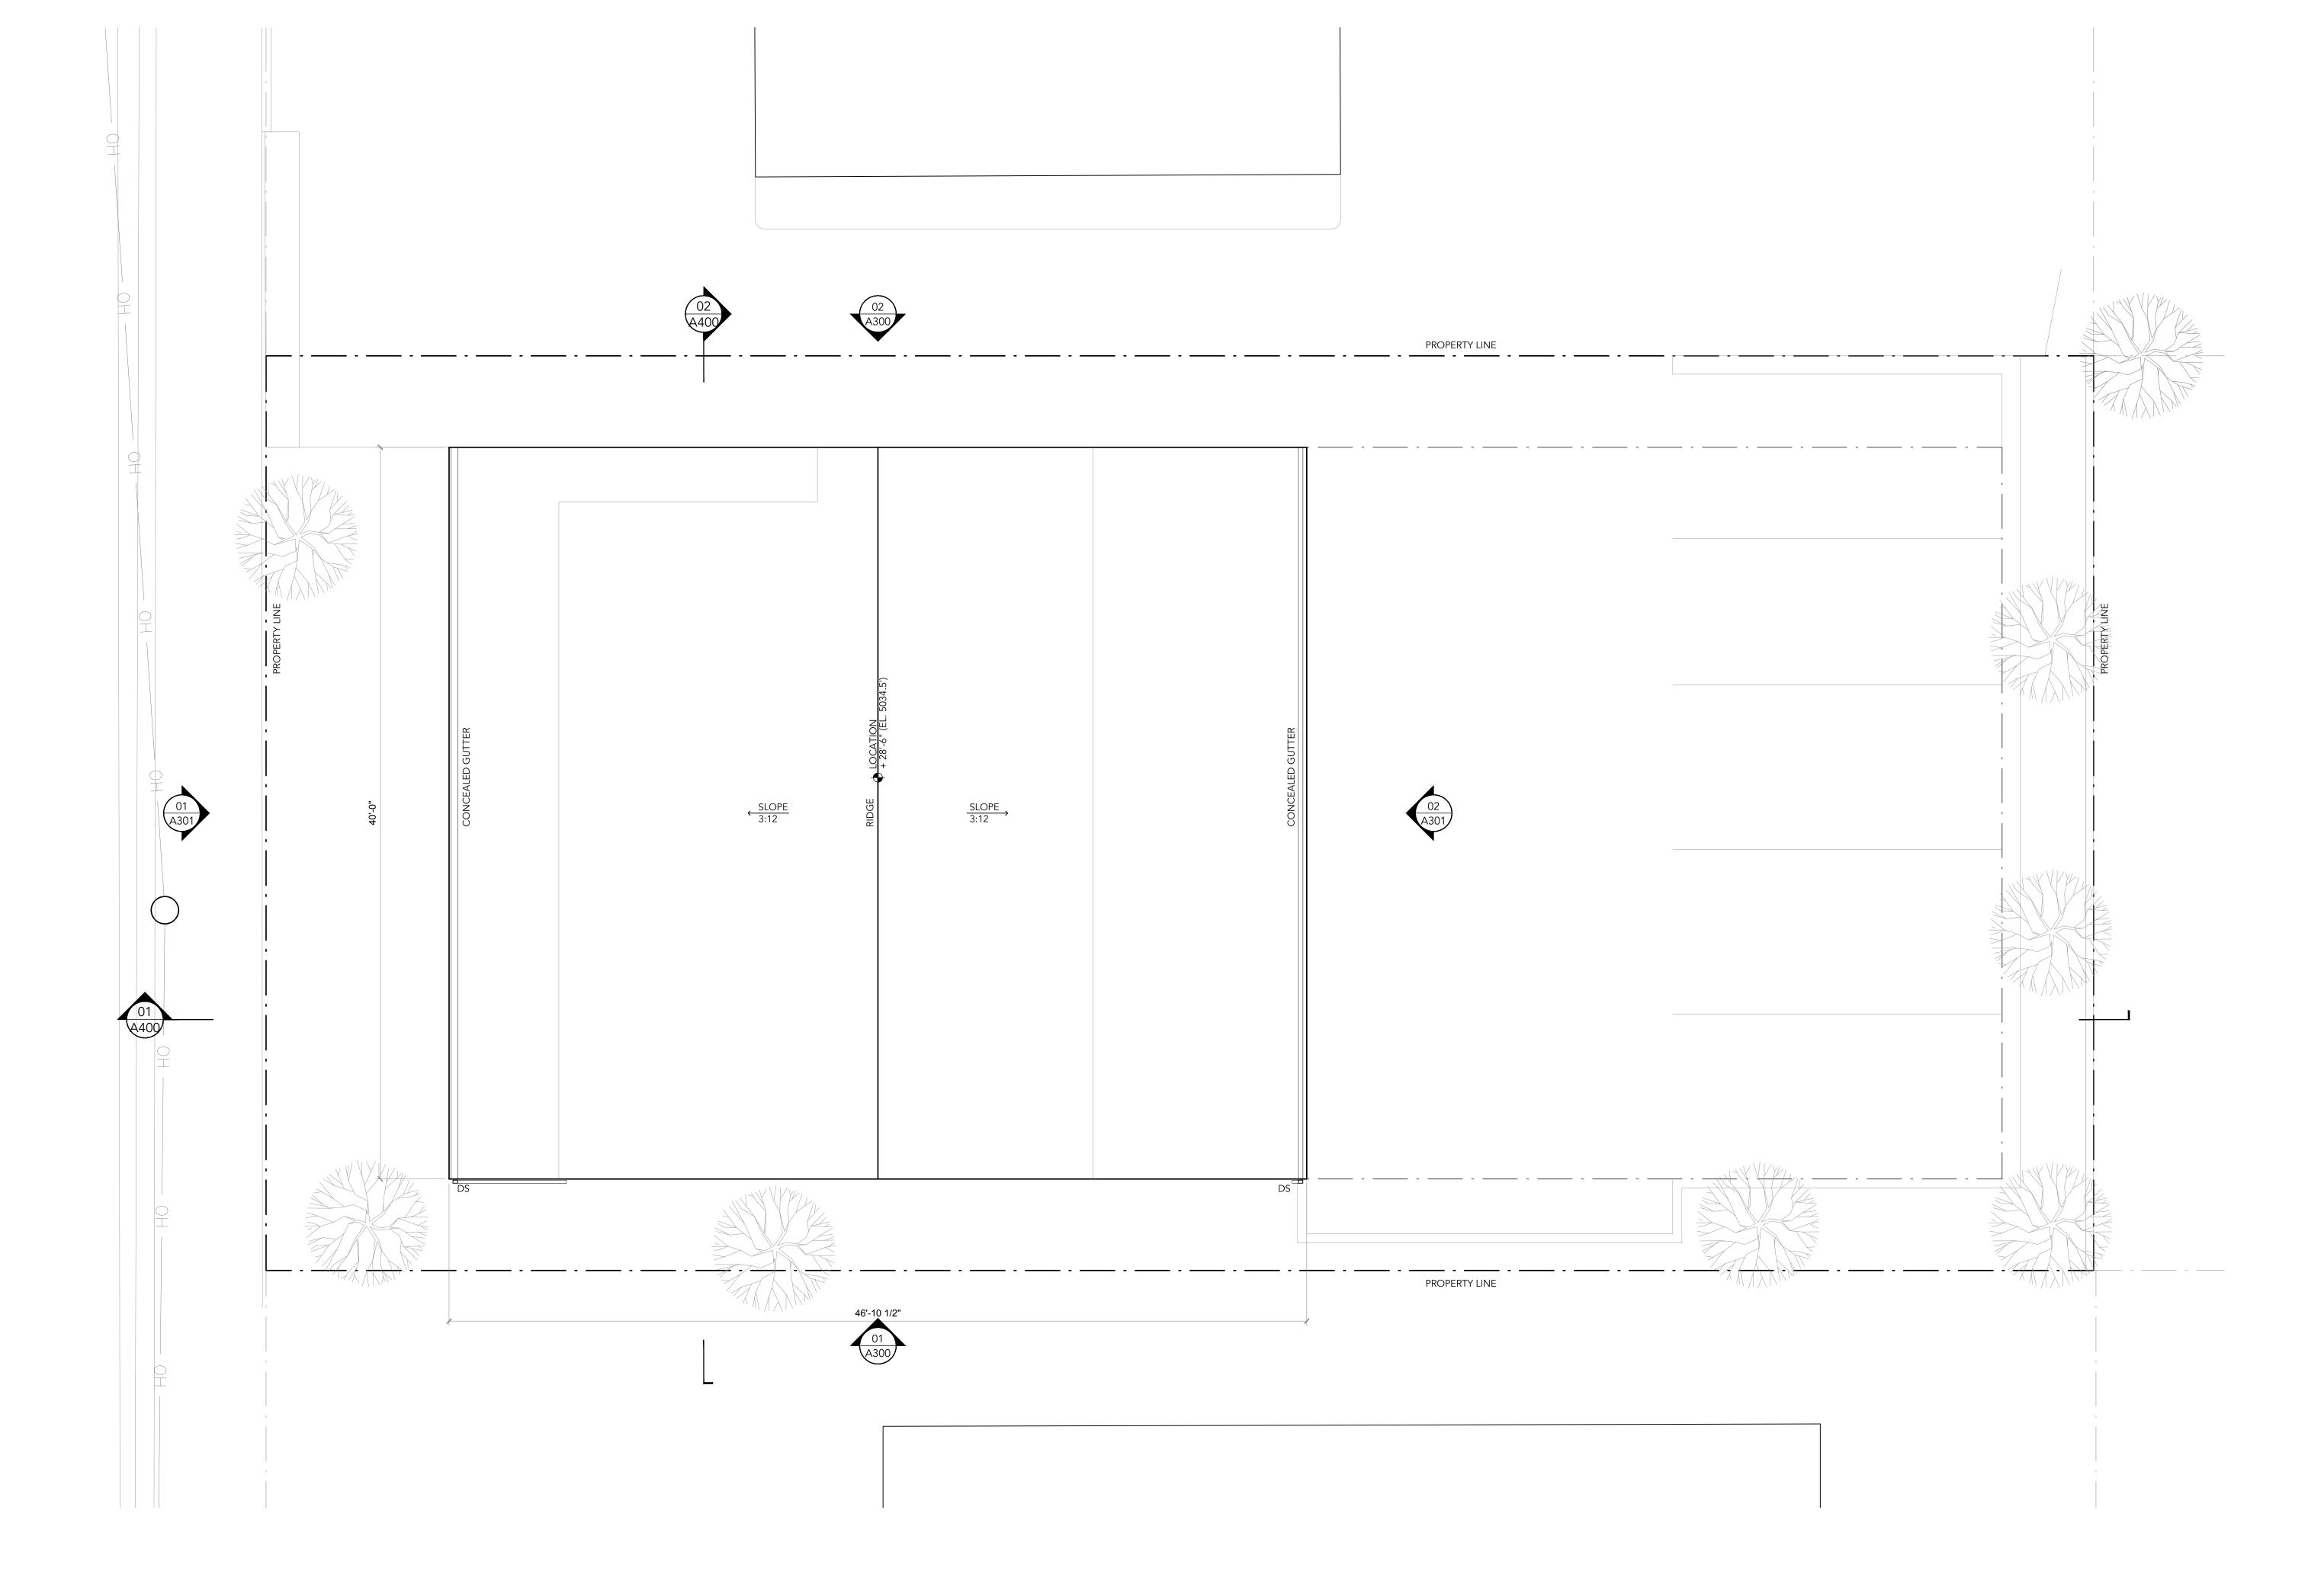

← T.O. SLAB MAIN LVL + 1'-2" (FFE 5007.66') ← AVE GROUND ELEV + 0'-0" (EL. 5006.5')

EXTERIOR ELEVATION: EAST SCALE: 1/4" 1 THIS DOCUMENT IS AN INSTRUMENT OF SERVICE AND THE PROPERTY OF CENTERFIELD STUDIO, LLC AND MAY NOT BE DUPLICATED OR REPRODUCED WITHOUT THEIR CONSENT.

A300 EXT ELEVATIONS 2X2 CEDAR SCREEN W/ METAL SUPPORTS PER STRUCTURAL




	Ĩ				
SHARED DRIVEWAY					

CENTERFIELD STUDIO, LLC 5392 TREE ST, LAKE OSWEGO OR, 97035 T:323.337.6967 / CENTERFIELDSTUDIO.COM → → MAX BLDG HEIGHT + 28'-6" (EL. 5034.5') EXECUTIVE ARCHITECT: ASPHALT COMPOSITE Method Design ROOFING SYSTEM METHOD DESIGN ARCHITECTURE + URBANISM, PLLC - LAP SIDING FIBER CEMENT 7" EXPOSED, 76 BEAVER STREET, FLOOR 02 T:646.559.4937 W:METHODDESIGN.COM PRIMED, PTD \_\_\_\_\_\_ <u>T.O. SHEATHING UPPER LVL</u> + 11'-11 7/8" 2X2 CEDAR SCREEN W/ METAL SUPPORTS PER STRUCTURAL AVE GROUND ELEV + 0'-0" (EL. 5006.5')


LEAD DESIGNER:


EXTERIOR ELEVATION: NORTH SCALE: 1/4" 2

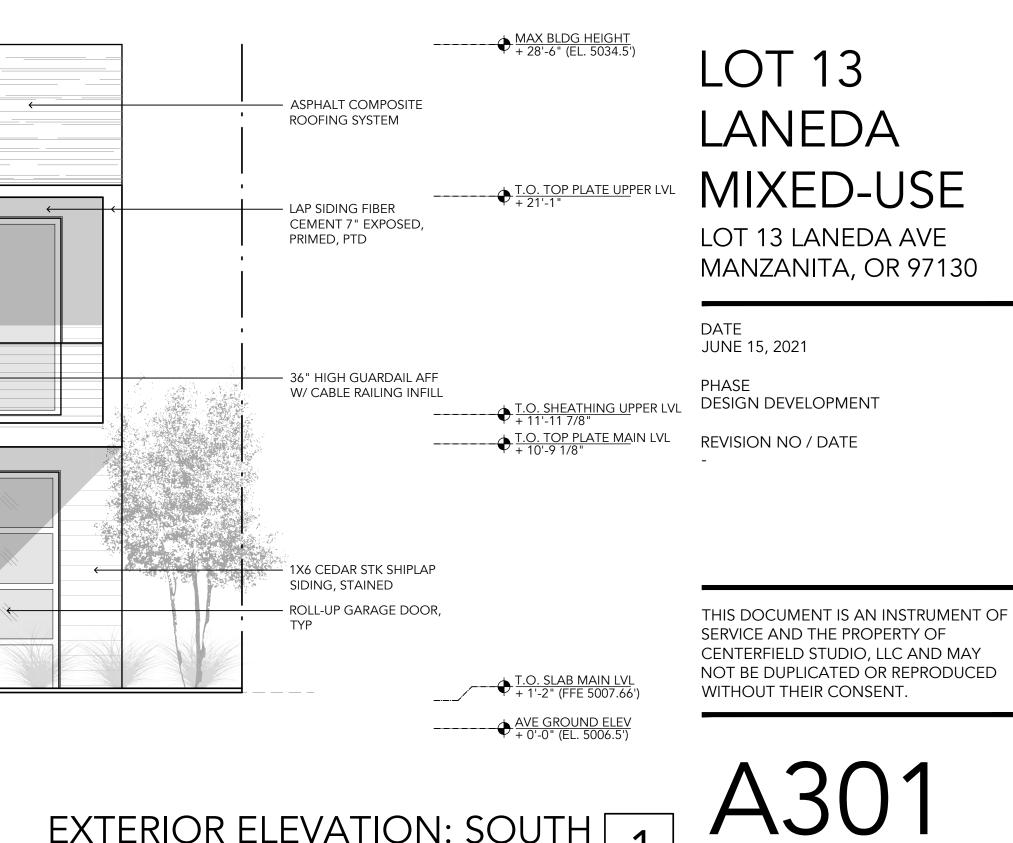

EXT ELEVATIONS

EXTERIOR ELEVATION: SOUTH 1 SCALE: 1/4" 

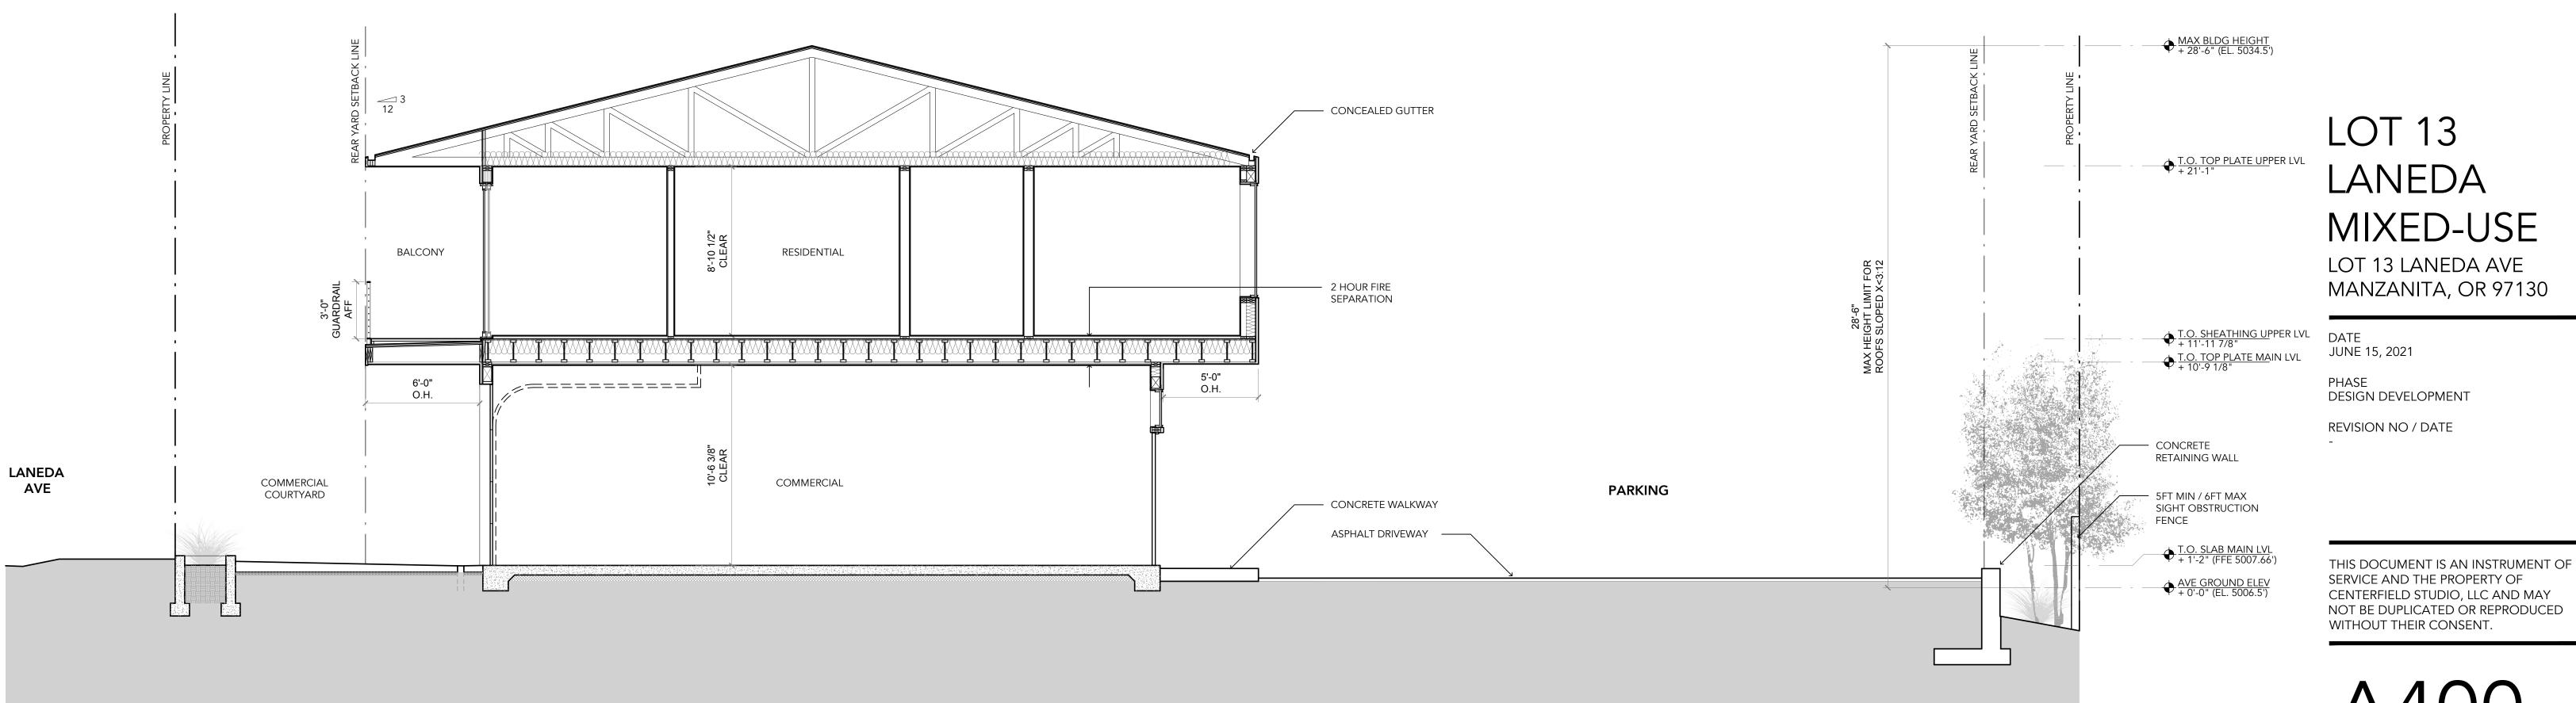

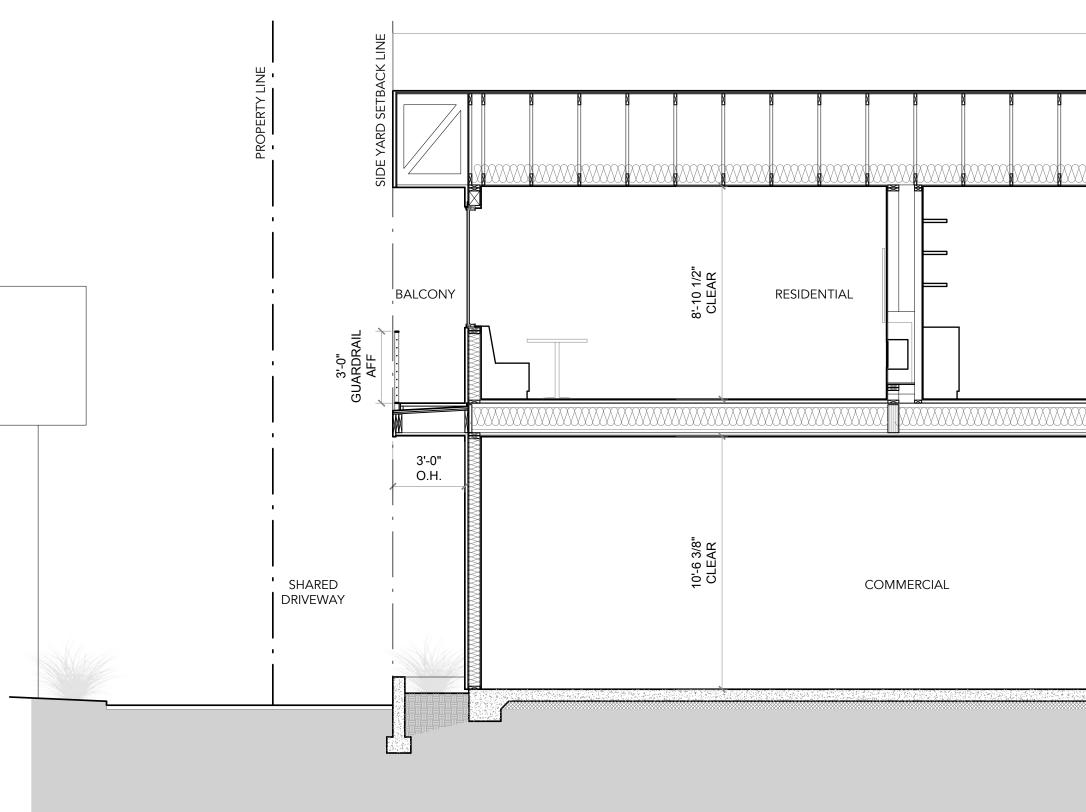

 ⊕ MAX BLDG HEIGHT
 + 28'-6" (EL. 5034.5') 

 <u>T.O. SHEATHING UPPER LVL</u>

 <u>T.O. TOP PLATE MAIN LVL</u>

 <u>T.O. 10'P 1/8"</u>
 



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# TYP BUILDING SECTION: HORIZONTAL 2 SCALE: 1/4"

TYP BUILDING SECTION: LONGITUDINAL SCALE: 1/4" 

**BLDG SECTIONS** 

A/C ACT	AT NUMBER	JT LAM L.F.	JOINT LAMINATE LINEAR FOOT	
	AIR CONDITIONING	LOC LVR	LOCATION	
AD	ACOUSTICAL CEILING TILE AREA DRAIN	MAT'L	MATERIAL	
ADJ AFF	ADJUSTABLE ABOVE FINISHED FLOOR	MAX MECH	MAXIMUM MECHANICAL	
ALT ALUM	ALTER OR ALTER NATE ALUMINUM	MEMB MTL	MEMBRANE METAL	Door Number
APPROX APPV	APPROXIMATE APPROVED	MFG MFR	MANUFACTURING MANUFACTURER	
ARCH	ARCHITECTURAL	MIN MISC	MINIMUM MISCELLANEOUS	01 Window Number
BD.	BOARD	M.O. MTD	MASONRY OPENING MOUNTED	
BITUM. BLDG	BITUMINOUS BUILDING	MUL	MULLION	←O1 Wall Type Tag
BLKG B.U.R.	BLOCKING BUILT UP ROOFING	Ν.	NORTH	Matarial Type Tag
CLR	CLEAR	N.I.C. NO.	NOT IN CONTRACT NUMBER	← XX-1 Material Type Tag (refers to Finish Sche
C.M.U. CONC	CONCRETE MASONRY UNIT CONCRETE	NOM. N/A	NOMINAL NOT APPLICABLE	
COND CONN	CONDITION OR CONDENSER CONNECTION	N.T.S.	NOT TO SCALE	$\leftarrow$ 1 Keynote Tag
CONST CONT	CONSTRUCTION CONTINUOUS	O/ O.C.	OVER ON CENTER	
CTR CTSK	CENTER COUNTERSUNK	O.D. O.D.	OUTSIDE DIAMETER OVERFLOW DRAIN (roof plan)	New Revision Are (Revision Number)
C.W.	COLDWATER	OVHD OPNG	OVERHEAD OPENING	(Revision Type) Lorem
D. DBL	DEEP, DEPTH DOUBLE	OPP PKG	OPPOSITE PACKAGE	
DET. DIA	DETAIL DIAMETER	PLBG PLYWD	PLUMBING PLYWOOD	ADD Old Revision Area
DIM	DIMENSION	PTD PW	PAINTED PICTURE WINDOW	
DN DWG	DOWN DRAWING	PWDR QTY	POWDER QUANTITY	⊕ LOCATION     ↓ 0'-0"     Datum Point
DWR	DRAWER			
(E) EA.	EXISTING EACH	RAD RD	RADIUS ROOF DRAIN	
ELEC ELEV	ELECTRICAL ELEVATION	REF REINF	REFERENCE REINFORCED, REINFORCING	00 Section Tag Drawing Number
E.O.S. EQ	EDGE OF SLAB EQUAL	REQ RESIL	REQUIRED RESILIENT	A000 Sheet Number
EQUIP E.W.	EQUIPMENT EACH WAY	REV RM	REVISED ROOM	
EXP EXPO	EXPANSION EXPOSED	RO	ROUGH OPENING	Exterior Elevation
EXPO	EXTERIOR	S. SCPD	SOUTH SOLID CORE PRIMED	00 Drawing Number Sheet Number
F.A. F.A.U.	FIRE ALARM FORCED AIR UNIT	SCHED SECT	SCHEDULE SECTION	A000 Sheet Number
F.D.	FLOOR DRAIN	SEP	SECTION SEPARATION, SEPARATE SIMILAR	A Interior Elevation
F.G. FIN.	FINISH GRADE FINISH FINISH	SIM SLDG SPEC	SIMILAR SLIDING SPECIFICATION	00 Drawing Number
FLR FLOUR.	FLOOR FLORESCENT	SPEC SQ STD	SPECIFICATION SQUARE STANDARD	B A000 D Sheet Number
F.O.C. F.O.F.	FACE OF CONCRETE FACE OF FINISH	STD STL STRCT'L	STEEL	č
F.O.S. FPRF	FACE OF STUD FIREPROOF			Detail Tag
FRMG FT	FRAMING FOOT, FEET	T&G T.D. TEL	TONGUE & GROOVE TOP OF DRAIN	A000 Drawing Number Sheet Number
FURR.	FURRING, FURRED	TEL TEMP	TELEPHONE TEMPERATURE	
GA GALV	GAUGE GALVANIZED	THK THR.	THICK, THICKNESS THRESHOLD	
GL GND	GLASS, GLAZING GROUND	T.P. T.O.S.	TOP OF PAVEMENT TOP OF SLAB / SHEATHING	ROOM C Room Name Room Number
GR GYP	GRADE GYPSUM	T.S. TV	TOP OF STEEL TELEVISION	
Н.	HIGH	T.O.W. TYP	TOP OF WALL TYPICAL	
н.в. Н.С.	HOSE BIB HOLLOW CORE	UNF	UNFINISHED	
HDWR HDWD	HARDWARE HARDWOOD	U.O.N.	UNLESS OTHERWISE NOTED	
HORIZ HR	HORIZONTAL HOUR	VERT	VERTICAL	
HT HVAC	HEIGHT HEATING, VENTILATION & AIRCON	V.I.F.	VERIFY IN FIELD VOLUME	
H.W.	HOT WATER	W.	WEST	
I.D. INCL	INSIDE DIAMETER INCLUDING	W/ W.H.	WITH WATER HEATER	
INSUL	INSULATION INTERIOR	W/O WD	WITHOUT WOOD	
	INTERIOR	WP WPM	WATERPROOF WATERPROOF MEMBRANE	
		WT	WEIGHT	
		ABB	REVIATIONS 1	1
		ABB	REVIATIONS SCALE: NTS	
		ABB		1 BUILDING CODE INFORMATION
		ABB		BUILDING CODE INFORMATION JURISDICTION: TILLAMOOK
		ABB		BUILDING CODE INFORMATION
		ABB		BUILDING CODE INFORMATION JURISDICTION: TILLAMOOK BUILDING CODE: 2019 OREGO ZONING: C-1 COMME
		ABB		BUILDING CODE INFORMATION JURISDICTION: TILLAMOOK BUILDING CODE: 2019 OREGO ZONING: C-1 COMME MIN REQUIRED SETBACKS: FRONT
		ABB		BUILDING CODE INFORMATION JURISDICTION: TILLAMOOK BUILDING CODE: 2019 OREGO ZONING: C-1 COMME
			SCALE: NTS	BUILDING CODE INFORMATION JURISDICTION: TILLAMOOK BUILDING CODE: 2019 OREGO ZONING: C-1 COMME MIN REQUIRED SETBACKS: FRONT SIDES REAR
	12	9 6	SCALE: NTS	BUILDING CODE INFORMATION JURISDICTION: TILLAMOOK BUILDING CODE: 2019 OREGO ZONING: C-1 COMME MIN REQUIRED SETBACKS: FRONT SIDES
			SCALE: NTS	BUILDING CODE INFORMATION JURISDICTION: TILLAMOOK BUILDING CODE: 2019 OREGO ZONING: C-1 COMME MIN REQUIRED SETBACKS: FRONT SIDES REAR
			SCALE: NTS	BUILDING CODE INFORMATION JURISDICTION: TILLAMOOK BUILDING CODE: 2019 OREGO ZONING: C-1 COMME MIN REQUIRED SETBACKS: FRONT SIDES REAR
		9 6	SCALE: NTS	BUILDING CODE INFORMATION JURISDICTION: TILLAMOOK BUILDING CODE: 2019 OREGO ZONING: C-1 COMME MIN REQUIRED SETBACKS: FRONT SIDES REAR
			SCALE: NTS	BUILDING CODE INFORMATION JURISDICTION: TILLAMOOK BUILDING CODE: 2019 OREGO ZONING: C-1 COMME MIN REQUIRED SETBACKS: FRONT SIDES REAR
		9 6	SCALE: NTS	BUILDING CODE INFORMATION JURISDICTION: TILLAMOOK BUILDING CODE: 2019 OREGO ZONING: C-1 COMME MIN REQUIRED SETBACKS: FRONT SIDES REAR
		9 6	SCALE: NTS	BUILDING CODE INFORMATION JURISDICTION: TILLAMOOK BUILDING CODE: 2019 OREGO ZONING: C-1 COMME MIN REQUIRED SETBACKS: FRONT SIDES REAR
		9 6	SCALE: NTS	BUILDING CODE INFORMATION JURISDICTION: TILLAMOOK BUILDING CODE: 2019 OREGO ZONING: C-1 COMME MIN REQUIRED SETBACKS: FRONT SIDES REAR
	11	9 6	SCALE: NTS	BUILDING CODE INFORMATION JURISDICTION: TILLAMOOK BUILDING CODE: 2019 OREGO ZONING: C-1 COMME MIN REQUIRED SETBACKS: FRONT SIDES REAR
ALL DRAY	11	9 6 8 5 7 4	SCALE: NTS	BUILDING CODE INFORMATION JURISDICTION: TILLAMOOK BUILDING CODE: 2019 OREGO ZONING: C-1 COMME MIN REQUIRED SETBACKS: FRONT SIDES REAR MAX HEIGHT LIMIT: 28'-6" FT
ALL DRAY	UNGS AND DETAILS ARE IDEN	9 6 8 5 7 4	SCALE: NTS	BUILDING CODE INFORMATION JURISDICTION: TILLAMOOK BUILDING CODE: 2019 OREGO ZONING: C-1 COMME MIN REQUIRED SETBACKS: FRONT SIDES REAR MAX HEIGHT LIMIT: 28'-6" FT
ALL DRA	UNGS AND DETAILS ARE IDEN	9 6 8 5 7 4	SCALE: NTS	D BUILDING CODE INFORMATION JURISDICTION: TILLAMOOK BUILDING CODE: 2019 OREGO ZONING: C-1 COMME MIN REQUIRED SETBACKS: FRONT BUILDING CODE: 2019 OREGO CONTRACTOR CON
ALL DRA	UNGS AND DETAILS ARE IDEN	9 6 8 5 7 4	SCALE: NTS	BUILDING CODE INFORMATION JURISDICTION: TILLAMOOK BUILDING CODE: 2019 OREGO ZONING: C-1 COMME MIN REQUIRED SETBACKS: FRONT SIDES REAR MAX HEIGHT LIMIT: 28'-6" FT

	OWNER SEAN AND MELISSA PIERCE
A	PO BOX 272 MANZANITA, OR 97130 SRP0010@GMAIL.COM (503) 329 - 4291
(1) Structural Grid Line	EXECUTIVE ARCHITECT
r	METHOD DESIGN 5392 TREE ST, LAKE OSWEGO, OR 97035 (323) 337-6967
s Smoke Alarm Indicator	STRUCTURAL ENGINEERING
hedule)	CONTRACTOR
(FE) Fire Extinguisher w/o Cabinet	TBD SITE INFORMATION
rea Clout and Tag <u>FEC</u> Cabinet	SITE ADDRESS:LOT 13, LANEDA AVE, MANZANITA, OR 97130COUNTY:TILLAMOOK
FAP Fire Alarm Pull a Clout and Tag	JURISDICTION:       CITY OF MANZANITA / TILLAMOOK COUNTY         ZONE:       C1 COMMERCIAL         LOT SIZE:       5,000 SF (0.11 ACRES)
Egress Path	TAX ID / PARCEL #:       14800, MAP 3N, 10W, 29AC
င္ ၂ Centerline ၂	SCOPE OF WORK NEW CONSTRUCTION OF A MIXED-USE TWO STORY STRUCTURE. SCOPE INCLUDES GROUND FLOOR COMMERCIAL GROUP B OCCUPANCY, UPPER LEVEL SINGLE UNIT RESIDENTIAL R3 OCCUPANCY WITH NEW AT GRADE PARKING AND LANDSCAPING.
- T	
in Tag	FLOOR AREAS         .65 X 5,000 SF LOT AREA = 3,250 SF MAX FLOOR AREA
n Tag	COMMERCIAL GROUND FLOOR 1,200 GSF
<u>_</u>	RESIDENTIAL UPPER FLOOR       1,325 GSF         TOTAL PROPOSED FLOOR AREA       2,525 GSF
	PARKING DWELLING ON LOTS 5,000 SF OR SMALLER: 1/UNIT FOR THE FIRST = 1 UNIT RESIDENTIAL OFFICE/SMALL RETAIL: 1/400 SF OF GROSS FLOOR AREA = 1200/400 = 3 UNITS COMMERCIAL
	TREES DEVELOPMENT PROPOSES REMOVAL OF 15 TREES. PER CITY OF MANZANITA, DEVELOPMENT PROPOSED 5 NEW REPLACEMENT TREES. SPECIES TO BE NATIVE. REFER TO LANDSCAPE PLAN FOR TREE SPECIFICATION.
	LANDSCAPE AREA PER MANZANITA ORD 95-4 SECTION 3.040.3.D, 10% OF SITE AREA SHALL BE DEVOTED TO LANDSCAPING: 5,000 SF SITE AREA = 500 SF MIN LANDSCAPE AREA
	PROVIDED LANDSCAPE AREA = 1,130 SF
	LIVING PLANT MATERIAL AREA PER MANZANITA ORD 95-4 SECTION 4.156.3 LIVING PLANT MATERIAL SHALL COVER AT LEAST 50% OF REQ LANDSCAPE AREA: 50% OF 500 SF REQ LANDSCAPE AREA = 250 SF MIN
	PROVIDED LIVING PLANT MATERIAL AREA = 630 SF
DRAWING SYMBOLS SCALE: NTS 8	PROJECT INFORMATION 5
	ENERGY EFFICIENCY / PERSCRIPTIVE ENVELOPE REQUIREMENTS PER TABLE C402.1.3
OK COUNTY / CITY OF MANZANITA SON STRUCTURAL SPECIALTY CODE	ALL CONDITIONED SPACES W/IN BUILDING SHALL COMPLY AS FOLLOWS: CLIMATE ZONE: ZONE 5 / MARINE (ZONE 4 ADJUSTED)
1ERCIAL	C1 GROUP R ROOFS
10 FT 5 FT 30 FT	INSULATION ABOVE ROOF DECKR30ciR30ciMETAL BUILDINGSR19+R11LSR19+R11LSATTIC AND OTHERR38R49MASSR11.4ciR13.3ci
	WALLS, ABOVE GRADEMASSR11.4ciR13.3ciMETAL BUILDINGR13+R13ciR13+R13ciMETAL FRAMEDR13+R7.5ciR13+R7.5ciWOOD FRAMEDR20R20+R3.8ci
	WALLS, BELOW GRADEBELOW GRADE WALLR7.5ci
	FLOORS MASS JOIST / FRAMINGR10ciR12.5ciR30R30
	SLAB ON GRADE FLOORSUNHEATED SLABSR10 for 24" belowHEATED SLABSR15 for 36" below + R5 full slab
	OPAQUE DOORSNONSWINGINGR4.75SWINGING DOORU0.37GARAGE DOOR <14% GLAZING
G CODE INFORMATION 7	ENERGY EFFICIENCY CODE
SCALE: NTS	SCALE: NTS 4





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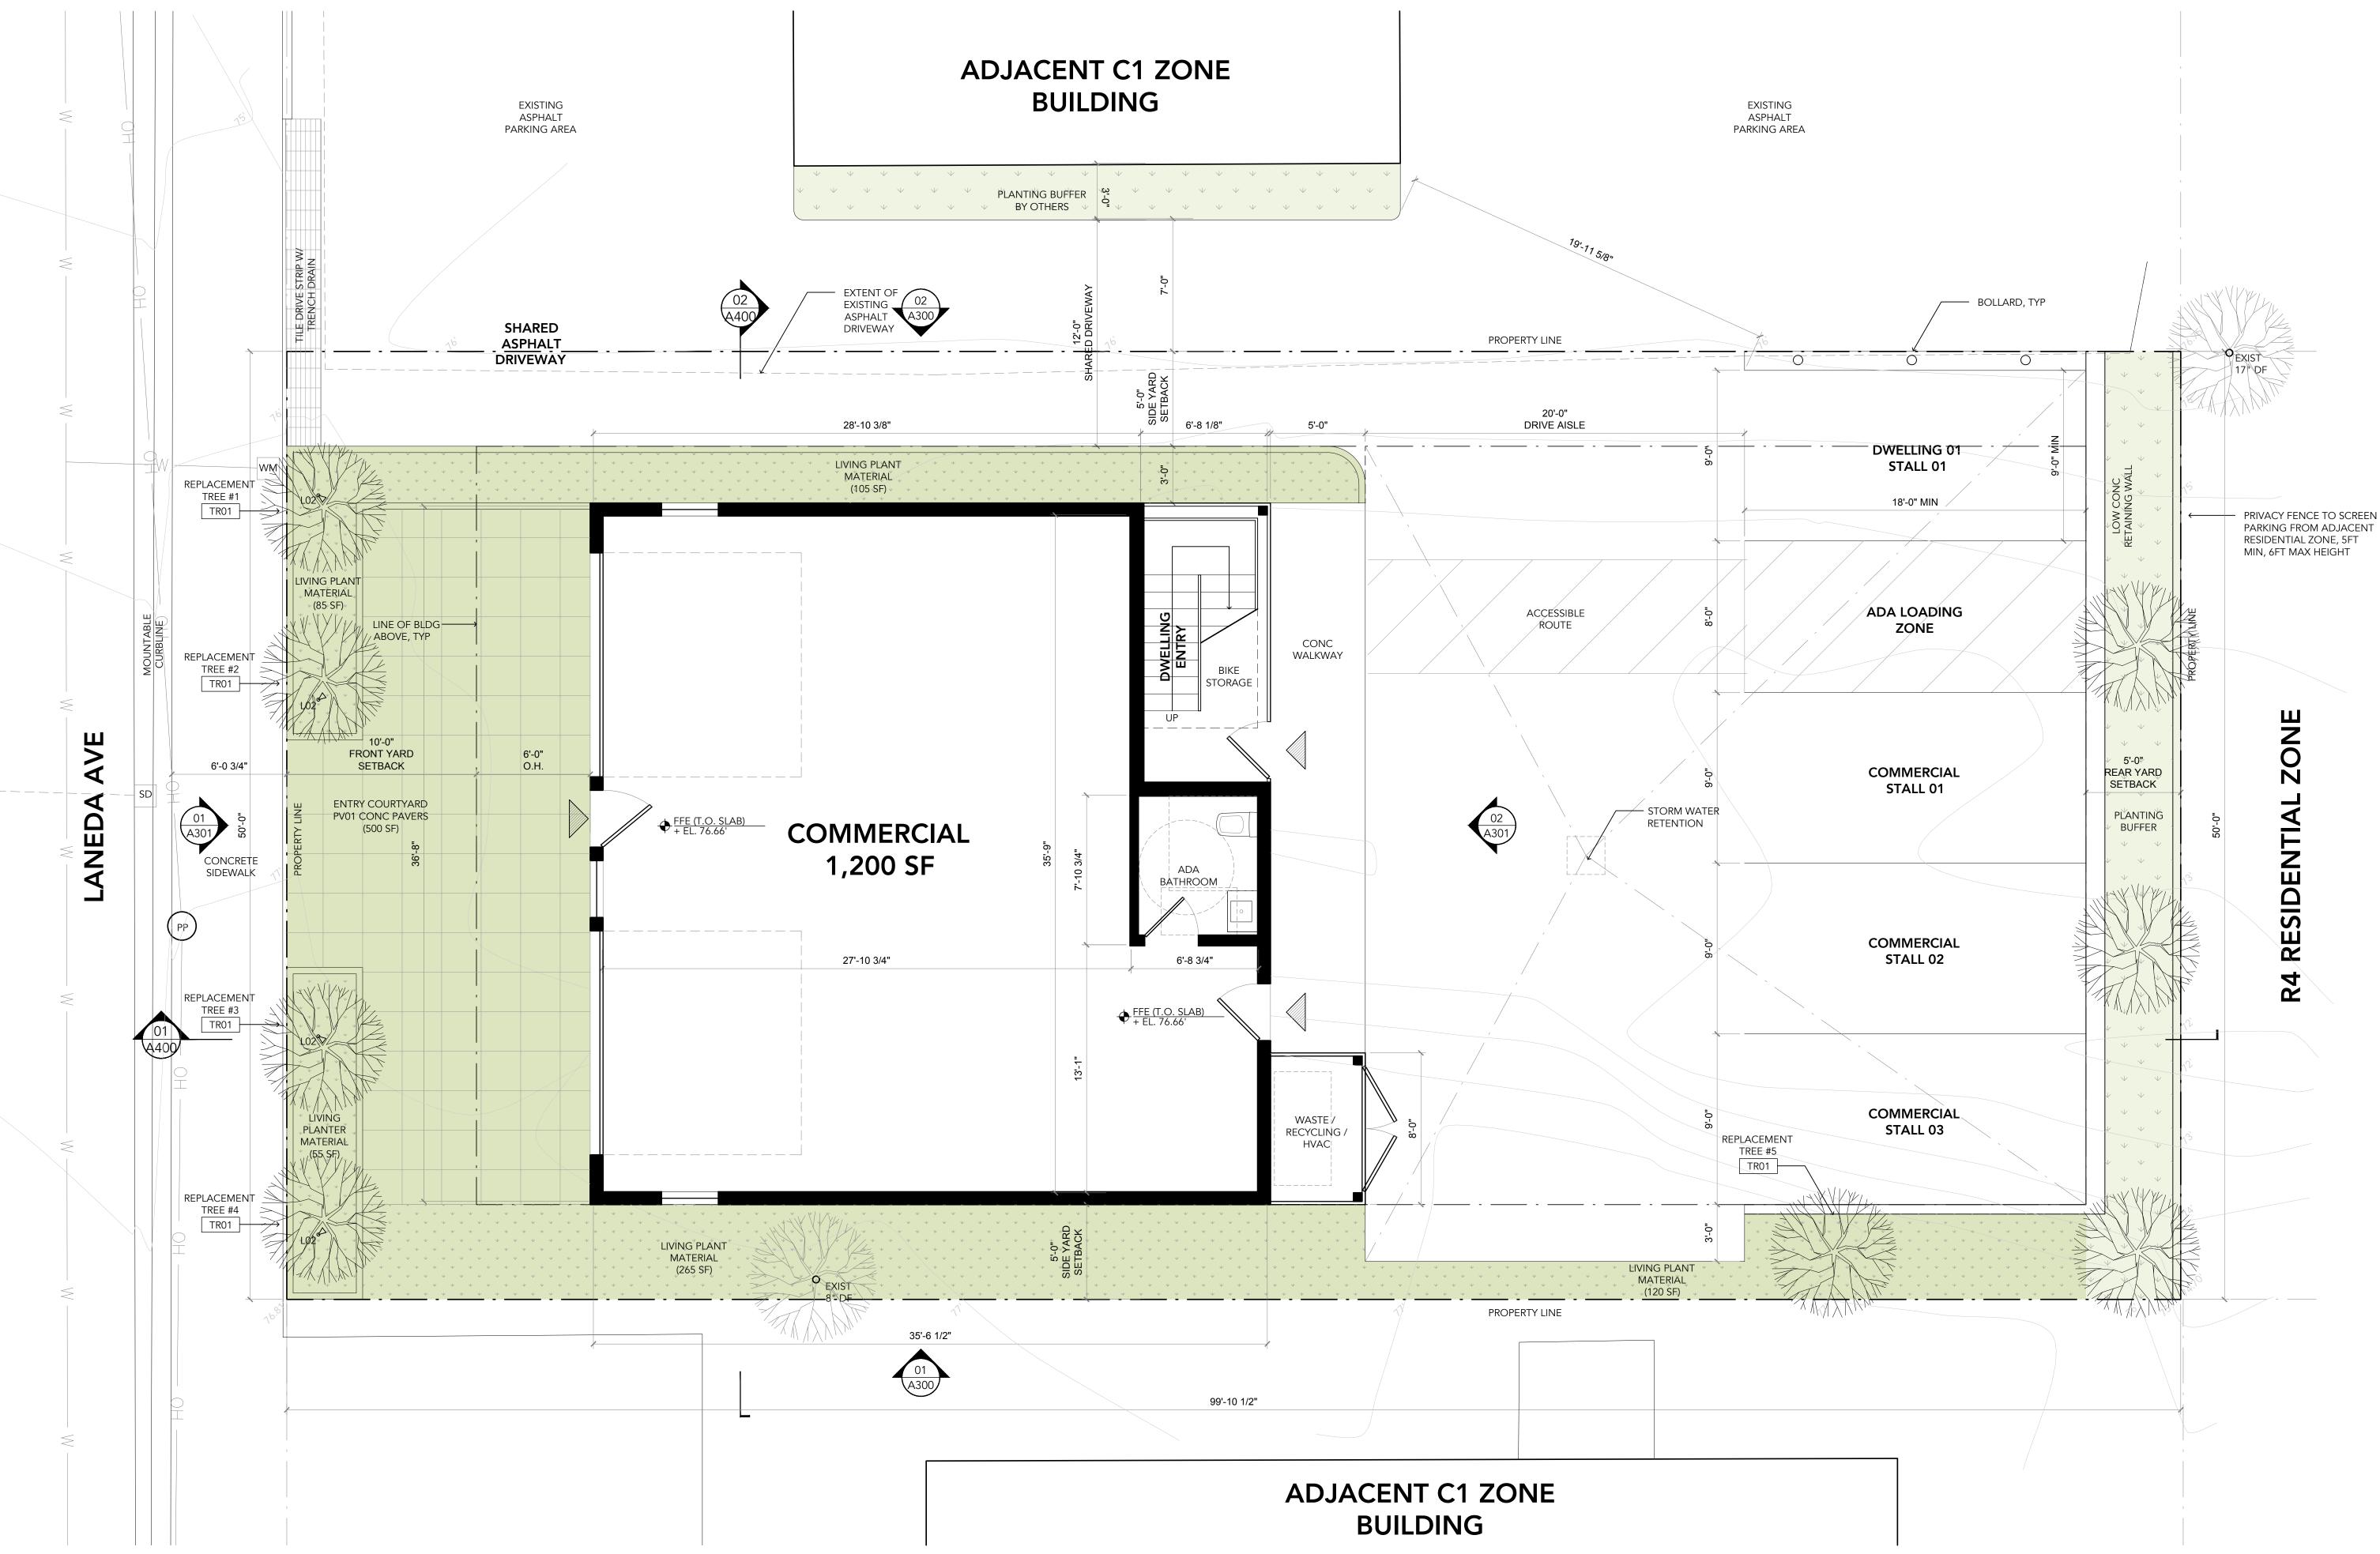
LOT 13 LANEDA MIXED-USE LOT 13 LANEDA AVE MANZANITA, OR 97130

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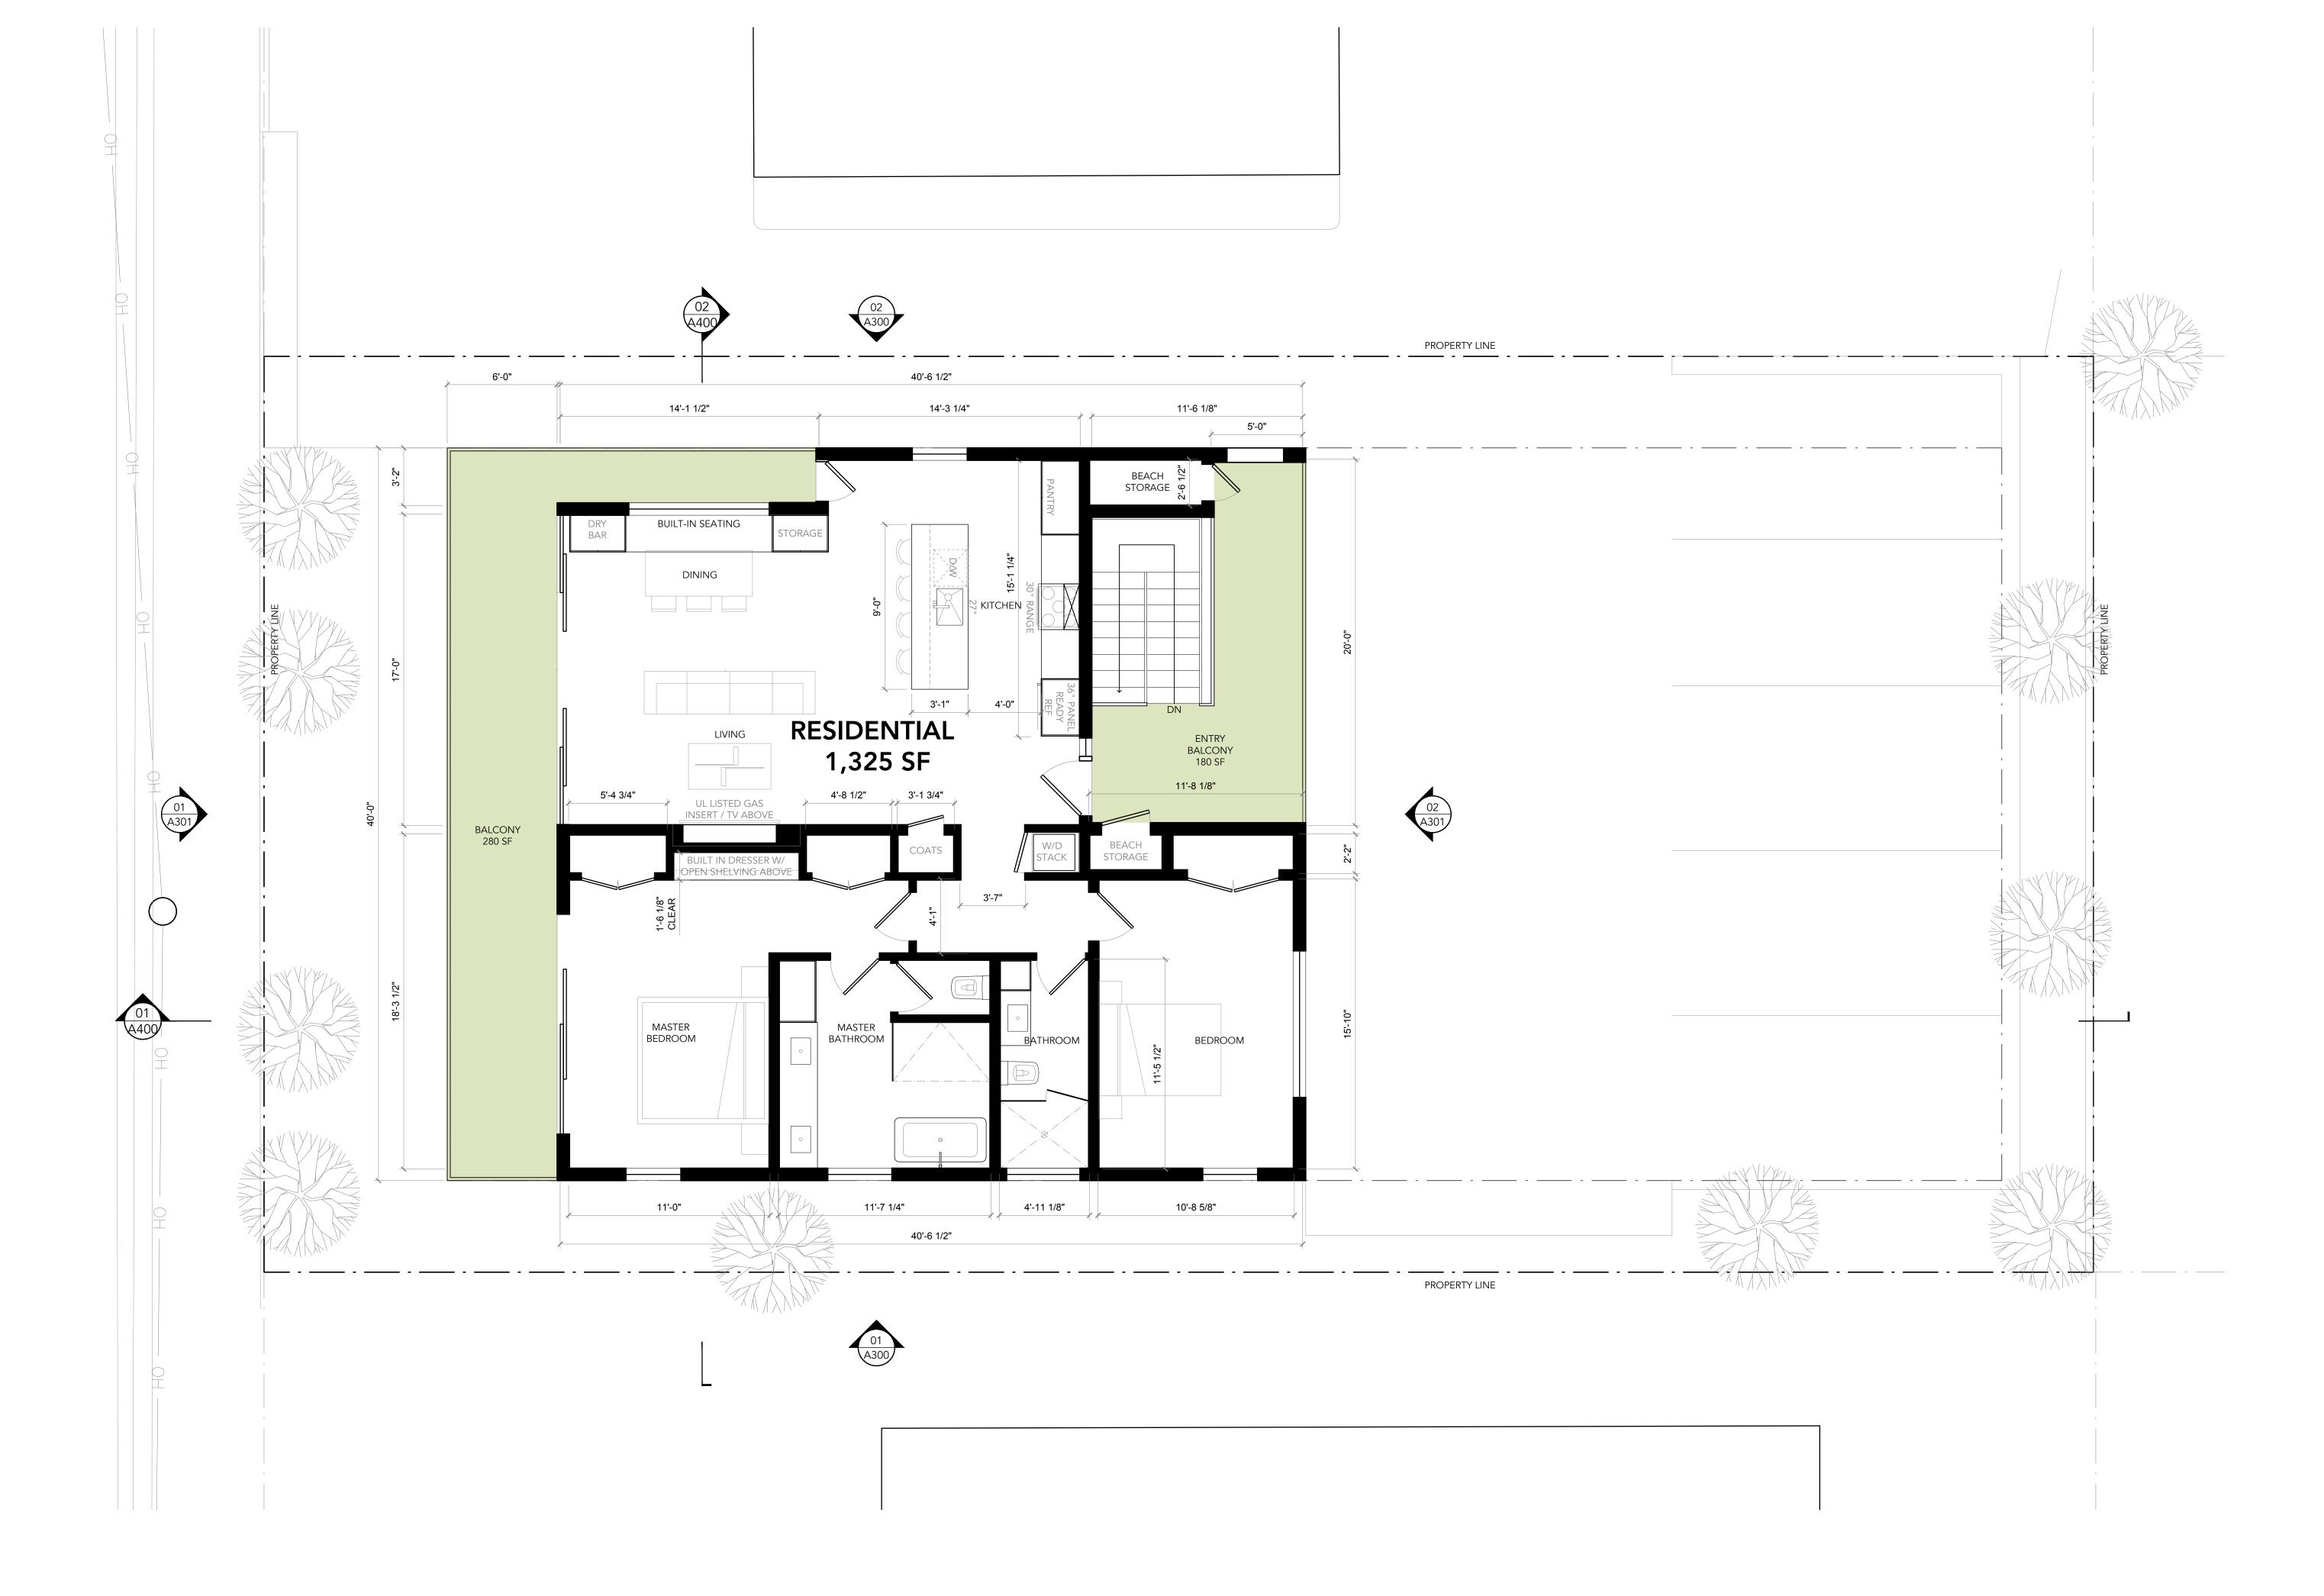
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SCALE: 1/4"



FLOOR PLAN: UPPER LEVEL (RESIDENTIAL) SCALE: 1/4" LEAD DESIGNER:



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EXECUTIVE ARCHITECT:




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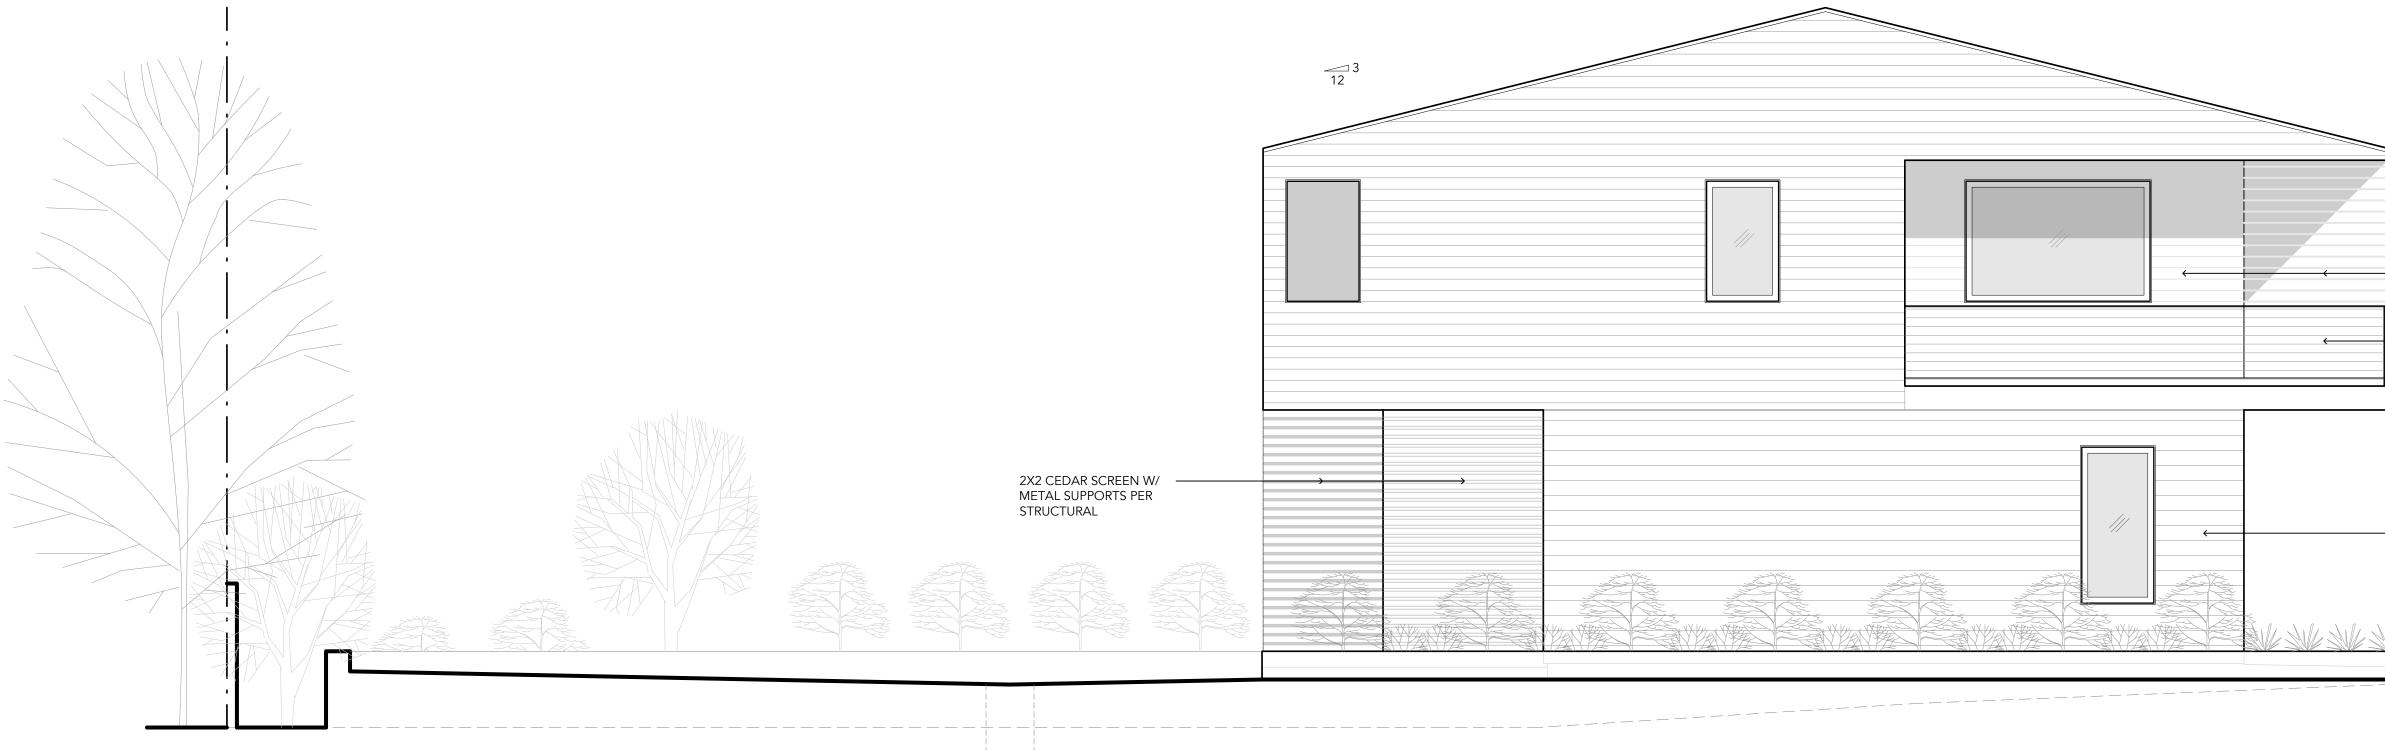
DATE JULY 15, 2021

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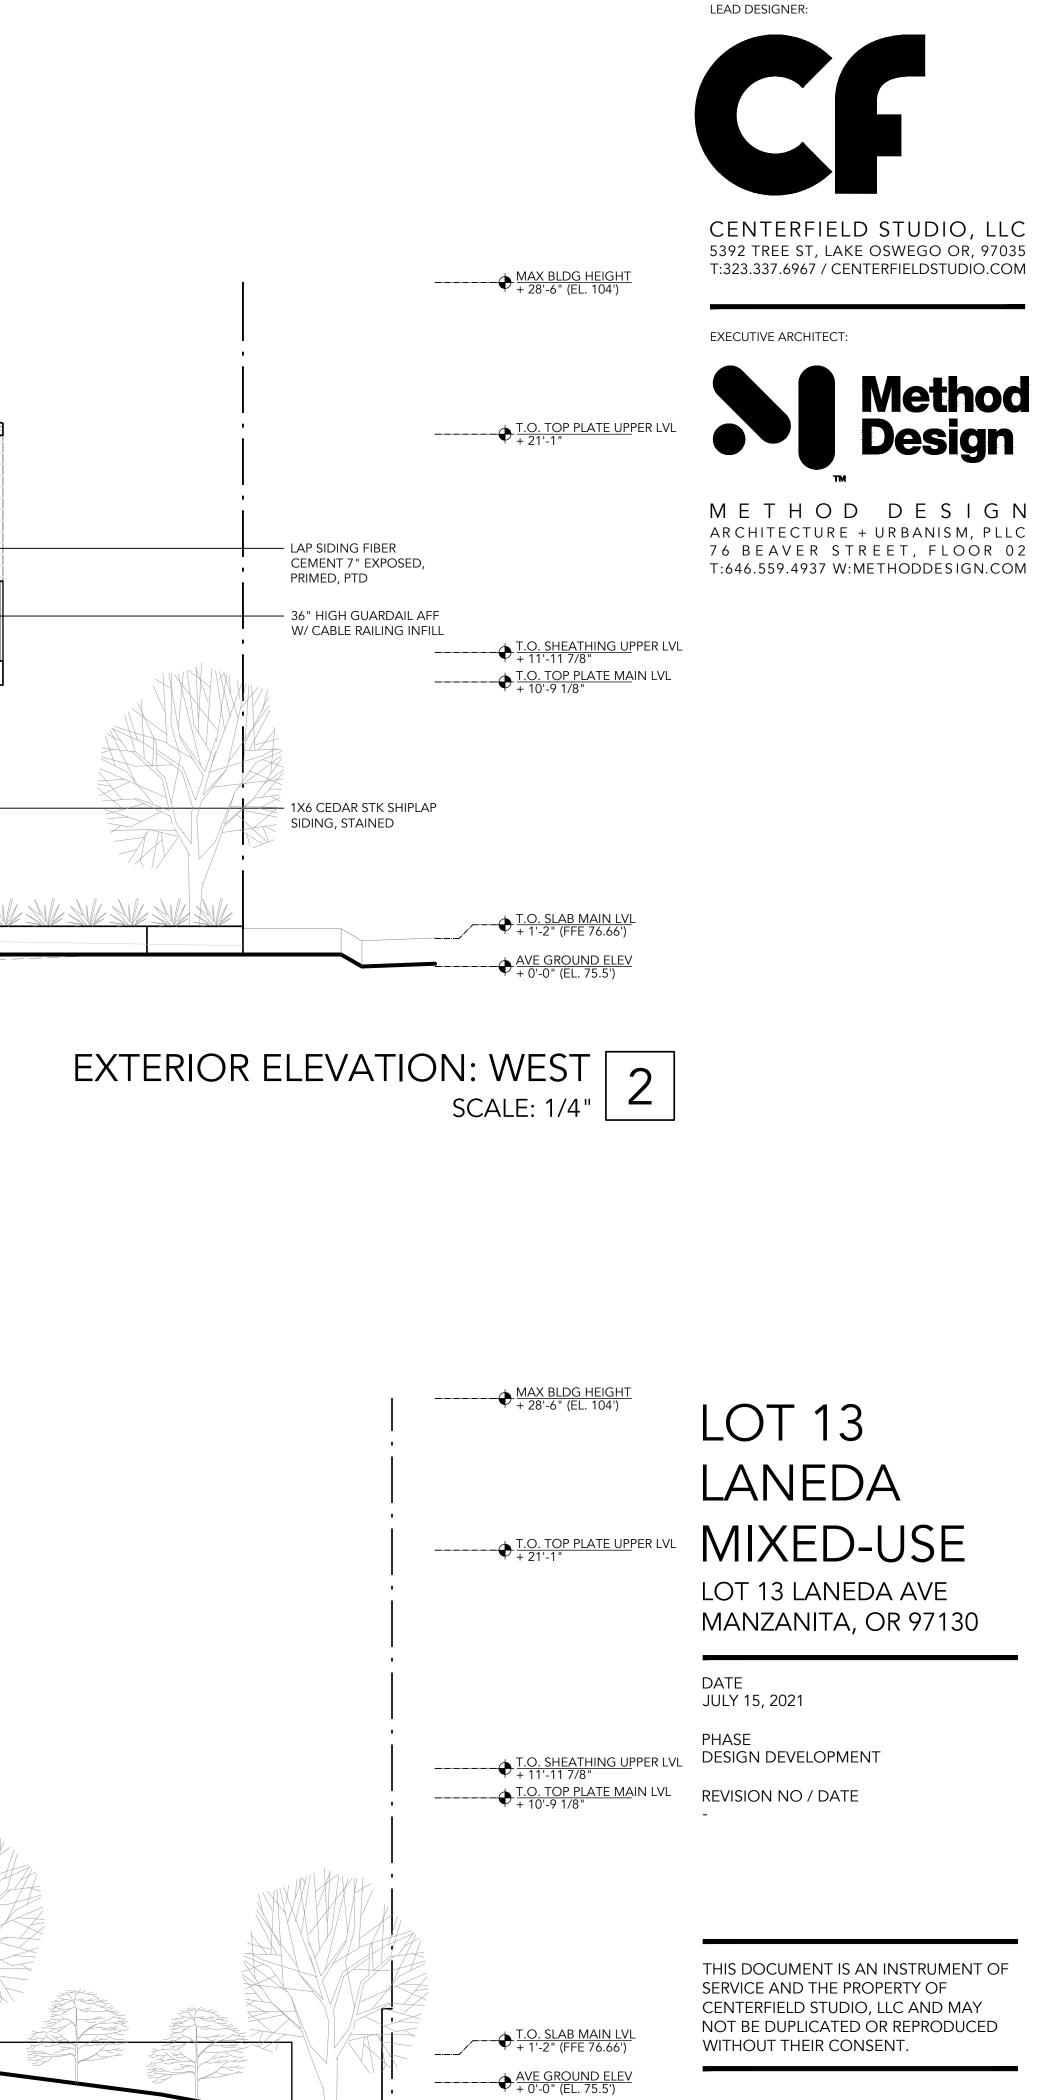
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ROOF PLAN SCALE: 1/4" 1






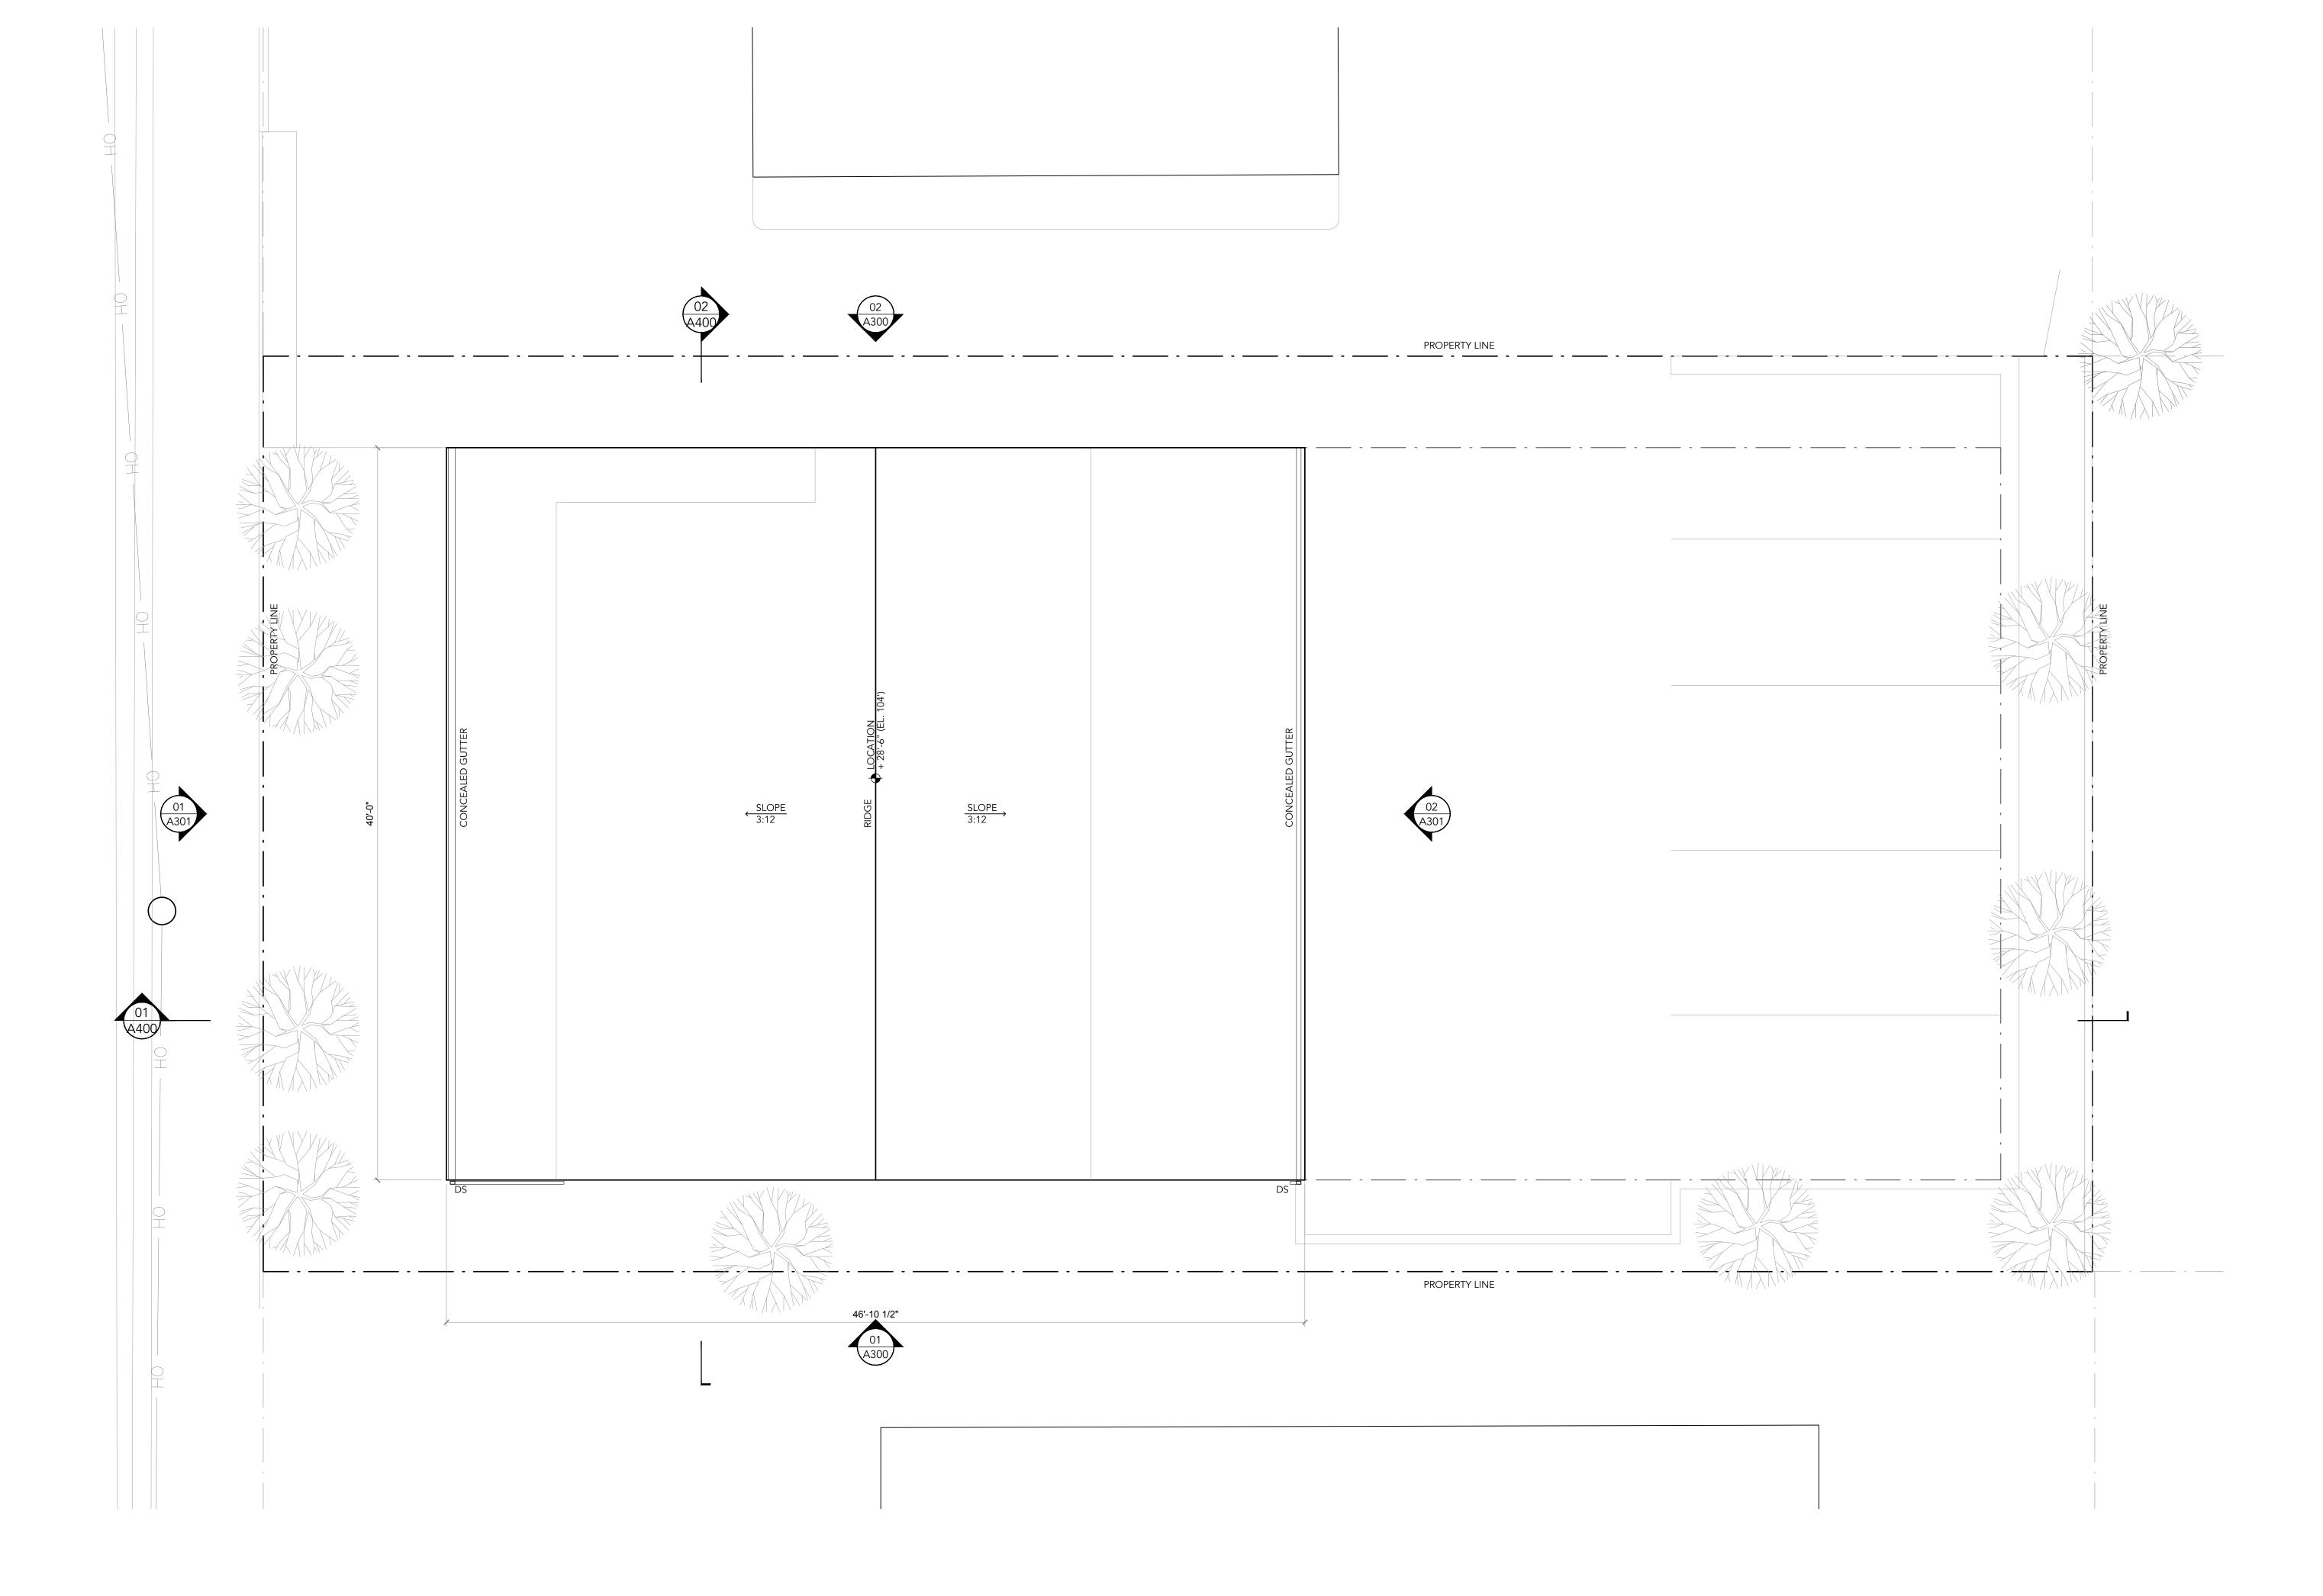

EXTERIOR ELEVATION: EAST 1


SCALE: 1/4"

A300 EXT ELEVATIONS

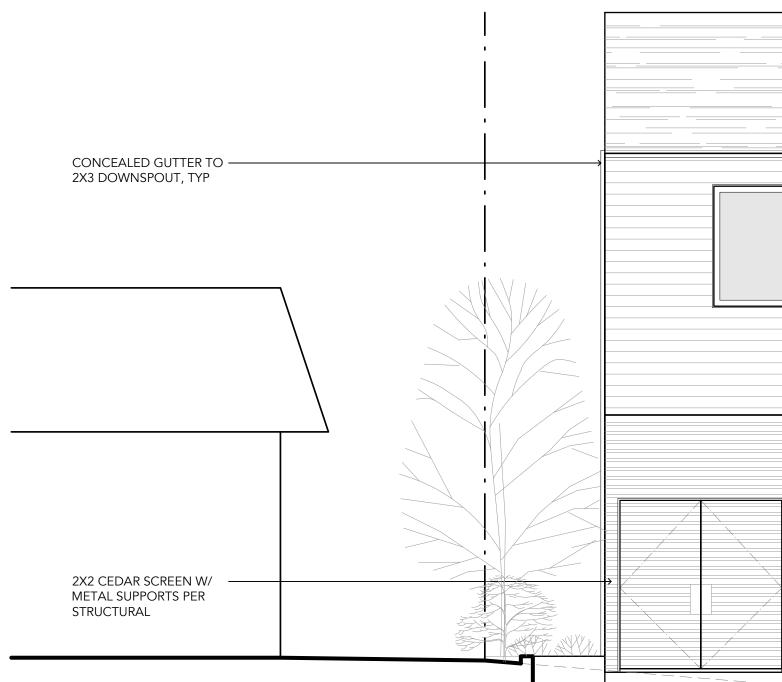



ASPHALT COMPOSITE ROOFING SYSTEM
4" OUTDOOR LED RECESSED LIGHT AT UNDERSIDE OF SOFFIT LAP SIDING FIBER CEMENT 7" EXPOSED, PRIMED, PTD 36" HIGH GUARDAIL AFF W/ CABLE RAILING INFILL
4" OUTDOOR LED RECESSED LIGHT AT UNDERSIDE OF SOFFIT L01 OUTDOOR WALL SCONCE, 2700K, TYP 1X6 CEDAR STK SHIPLAP SIDING, STAINED 2X2 CEDAR SCREEN W/ METAL SUPPORTS PER STRUCTURAL

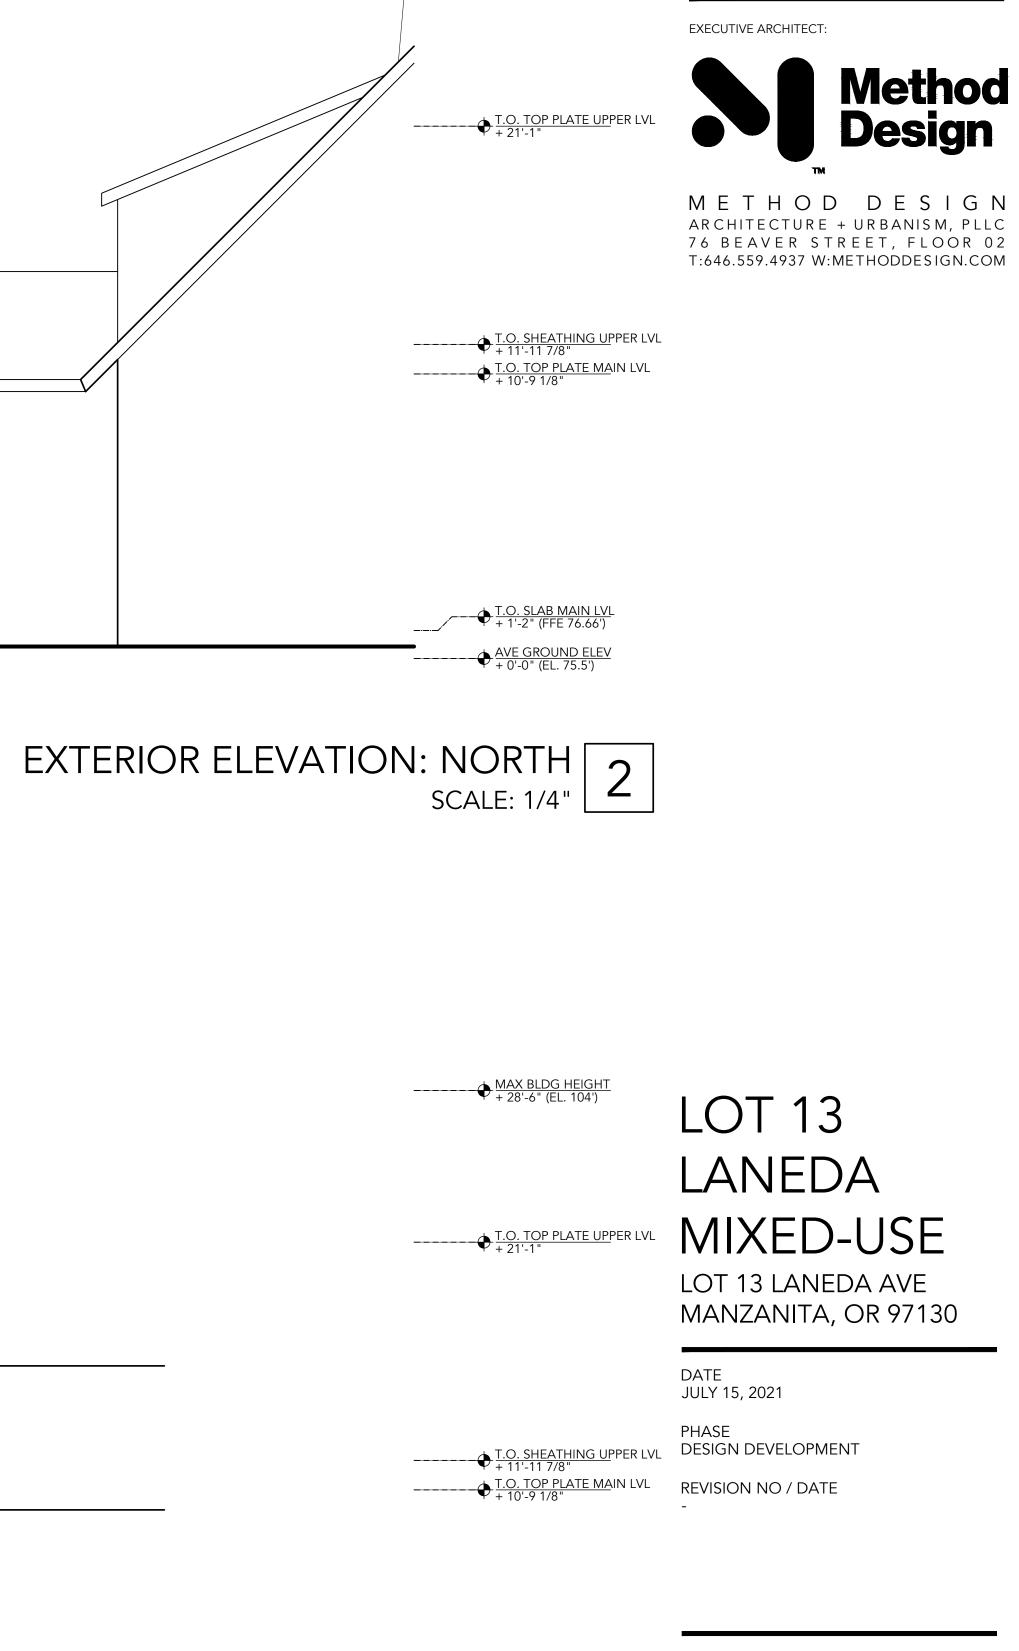


LEAD DESIGNER:


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A301 EXT ELEVATIONS


EXTERIOR ELEVATION: SOUTH 1 SCALE: 1/4"



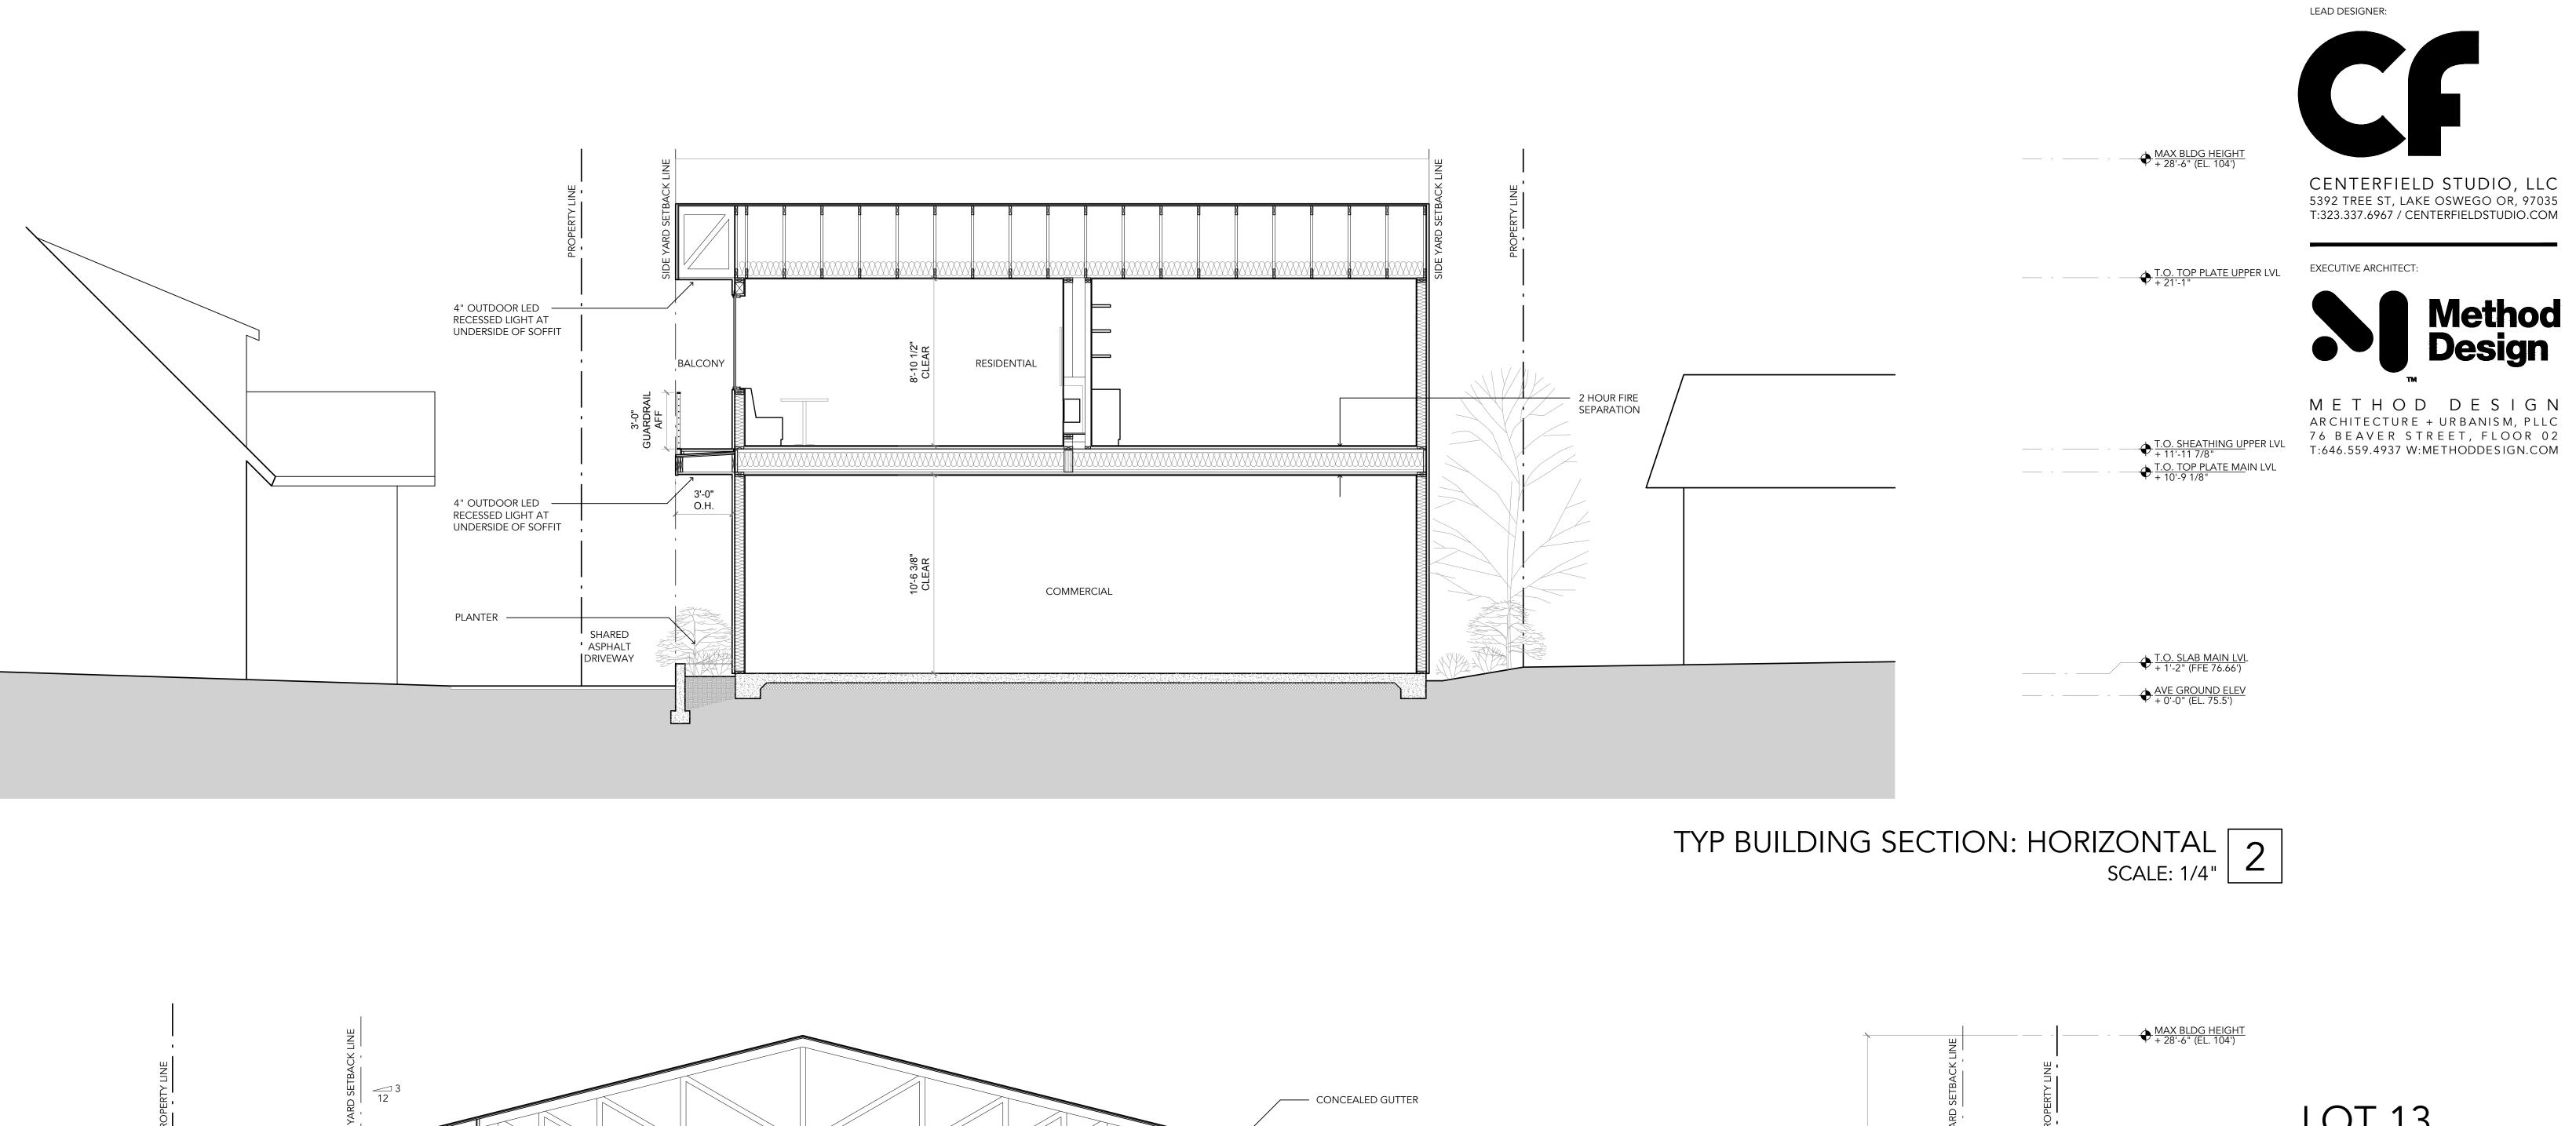

TYP BUILDING SECTION: LONGITUDINAL 1 SCALE: 1/4" [ 

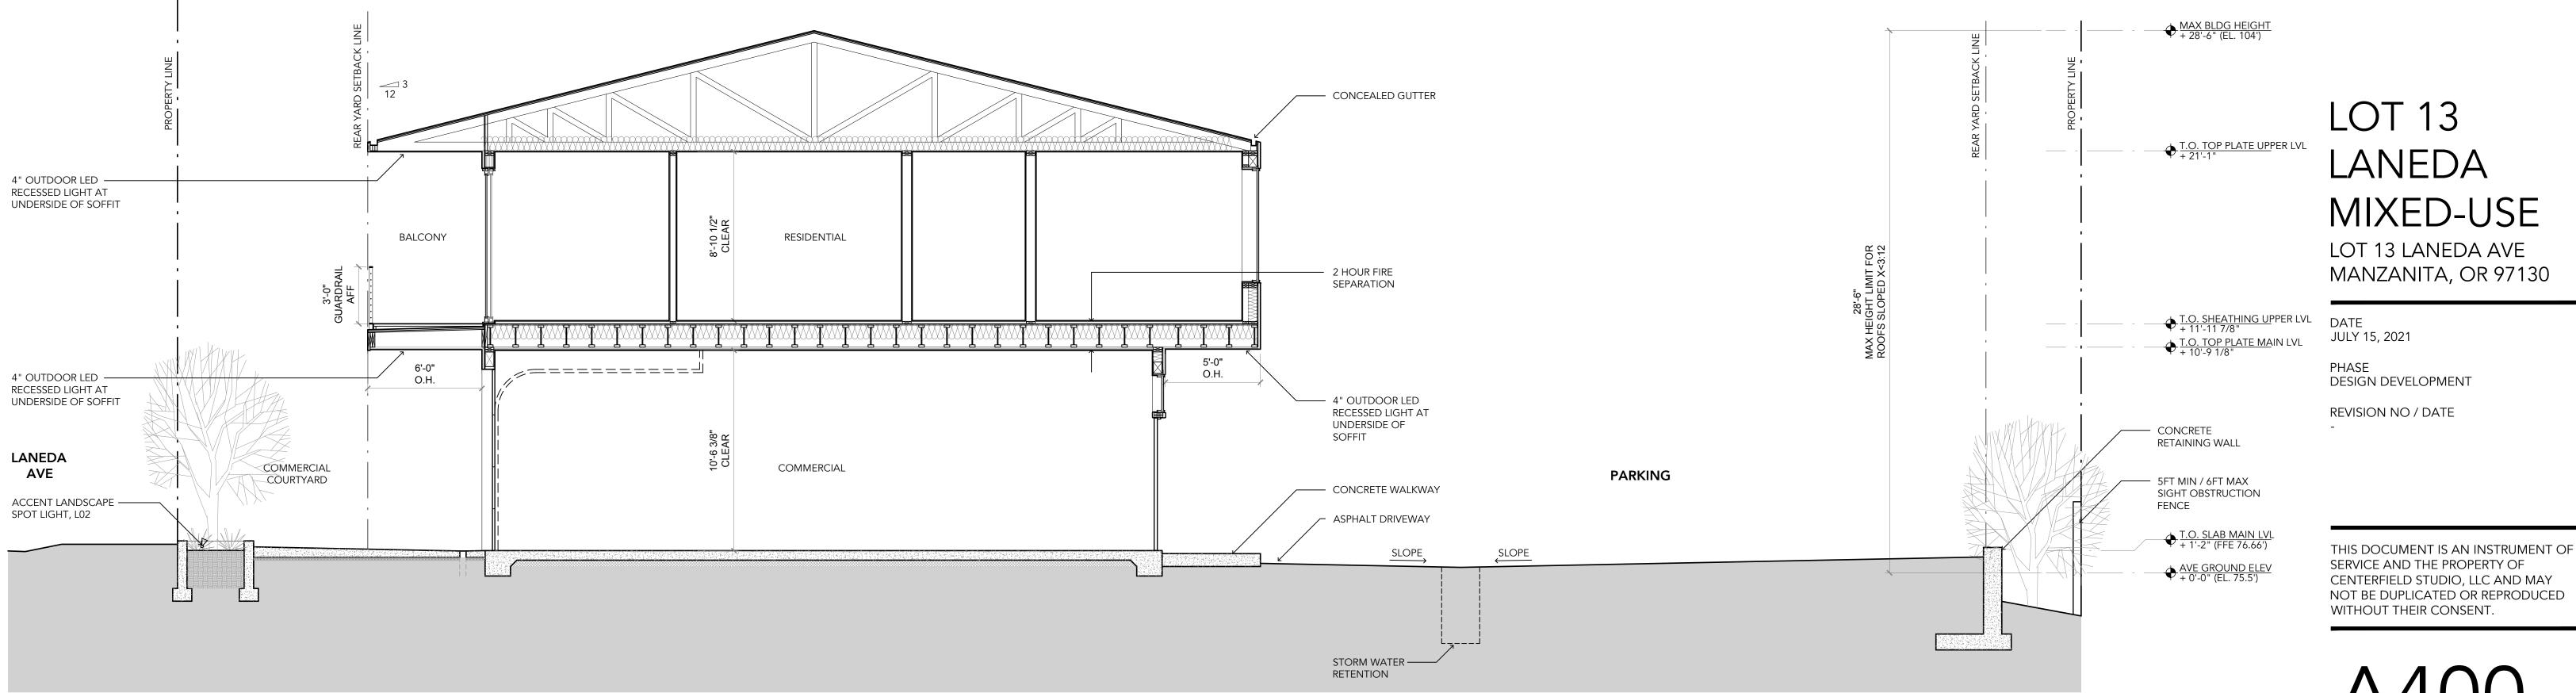**BLDG SECTIONS** 

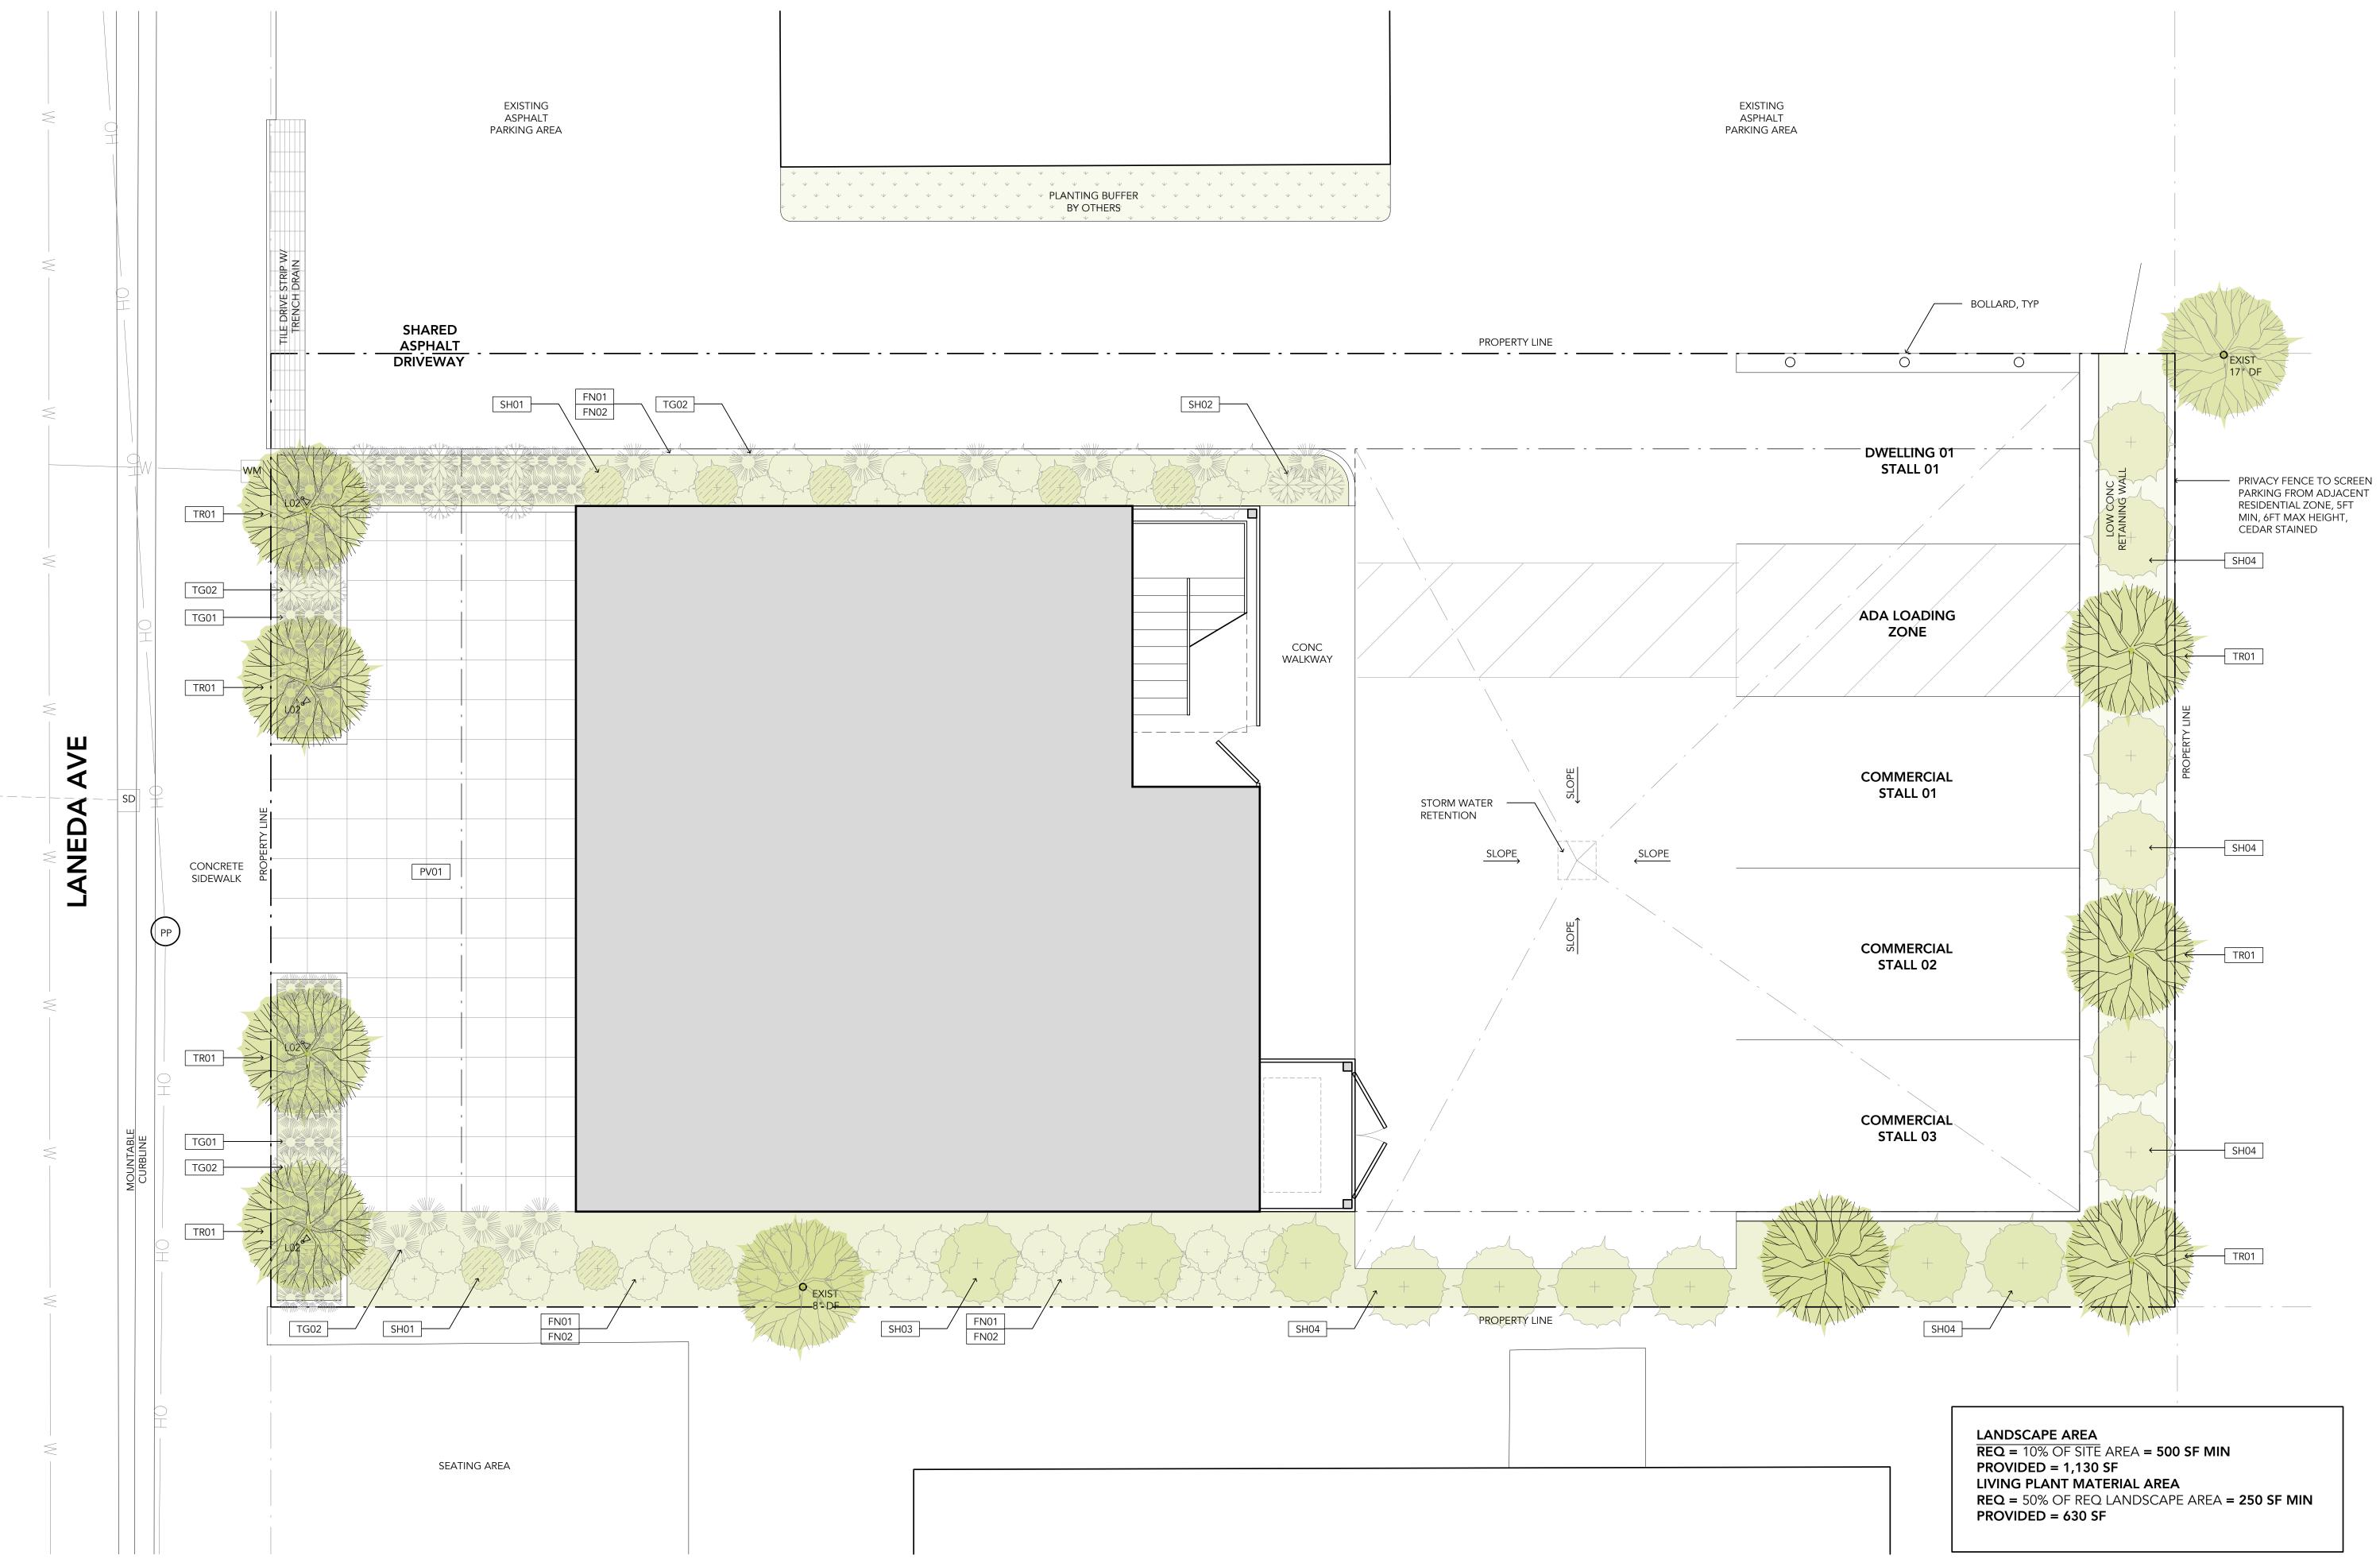

LOT 13 LANEDA MIXED-USE LOT 13 LANEDA AVE MANZANITA, OR 97130

DATE JULY 15, 2021

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## LANDSCAPE PLAN LANDSCAPE PLAN SCALE: 1/4"

LEAD DESIGNER:




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### TREES



TR01: Acer Circinatum Vine Maple

### GRASSES / SEDGES

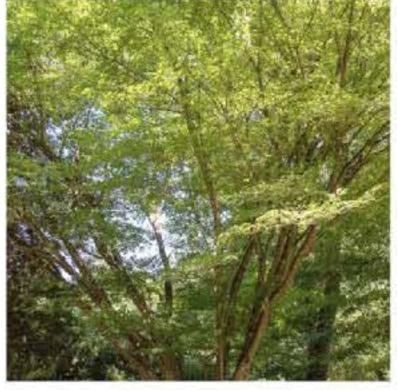

TG01: Carex Obnupta Slough Sedge

TG02: 'All Gold' Japanese Forest Grass

TG03: Deschampsia Cespitosa Tufted Hairgrass

### SHRUBS



SH01: Arctostaphylos Densiflora 'Harmony' Manzanita FERNS

SH02: 'Nikko Blue' Hydrangea

SH03: Vaccinium Parvifolium 'Red Huckleberry




F01: Pteridium Aquilinum Western Bracken Fern

F02: Polystichum Munitum Sword Fern

SH04: Salix Hookeriana Hooker 'Coast' Willow

## HARDSCAPE

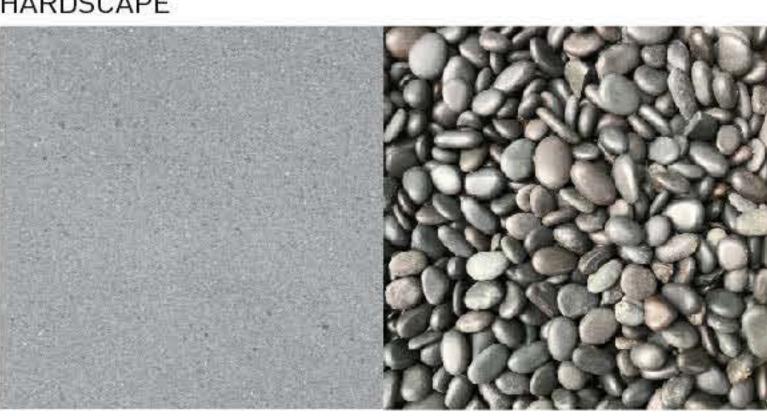

PV01: 2x2 Acid Etched **Concrete Pavers** 

LIGHTING



Wall Sconce, 65W, Black

## LANDSCAPE PLANT AND LIGHTING SCHEDULE

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AGG01: Premium Polished Black Rock 3/8"



L01: 5"x14.25" LED Outdoor L02: 3 1/4" LED Accent Spot Light, 5W, 2700K, Black


SCALE: NTS


LOT 13 LANEDA MIXED-USE LOT 13 LANEDA AVE MANZANITA, OR 97130

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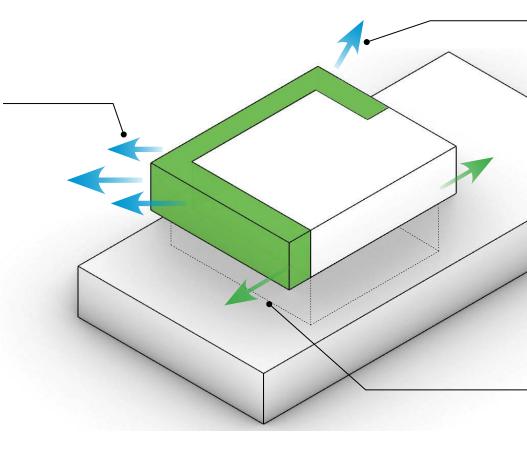
LANEDA AVE

COMMERCIAL LEVEL

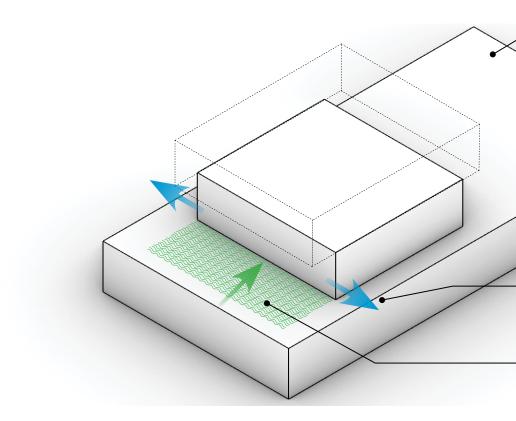

MAXIMIZE COMMERICAL STREET FRONTAGE ALONG LANEDA AVE

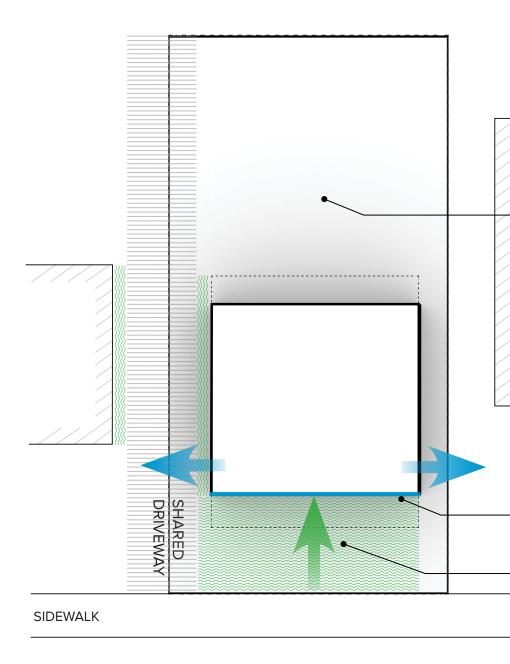MAXIMIZE OPEN SPACE ALONG LANEDA AVE CREATE VIEWING OPPORTUNITIES OF PACIFIC OCEAN TO THE SOUTHWEST



LOCATE PARKING TO THE REAR OF THE SITE
CREATE VIEWING OPPORTUNITIES OF PACIFIC OCEAN TO THE SOUTHWEST
MAXIMIZE COMMERICAL STREET FRONTAGE ALONG LANEDA AVE MAXIMIZE OPEN SPACE ALONG LANEDA AVE

**RESIDENTIAL LEVEL** 

LEAD DESIGNER:



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BELOW

EXTEND RESIDENTIAL FOOTPRINT

SOUTH TO CREATE OVERHANG FOR COMMERCIAL COURTYARD

CREATE VIEWING OPPORTUNITIES

OF NEAHKAHNIE MOUNTAINS

TO THE NORTHWEST

EXTEND RESIDENTIAL FOOTPRINT NORTH TO CREATE OVERHANGS FOR WALKWAY AND ENTRY(S) BELOW

EXTEND RESIDENTIAL FOOTPRINT SOUTH TO CREATE OVERHANG FOR COMMERCIAL COURTYARD BELOW

## LOT 13 LANEDA MIXED-USE LOT 13 LANEDA AVE MANZANITA, OR 97130

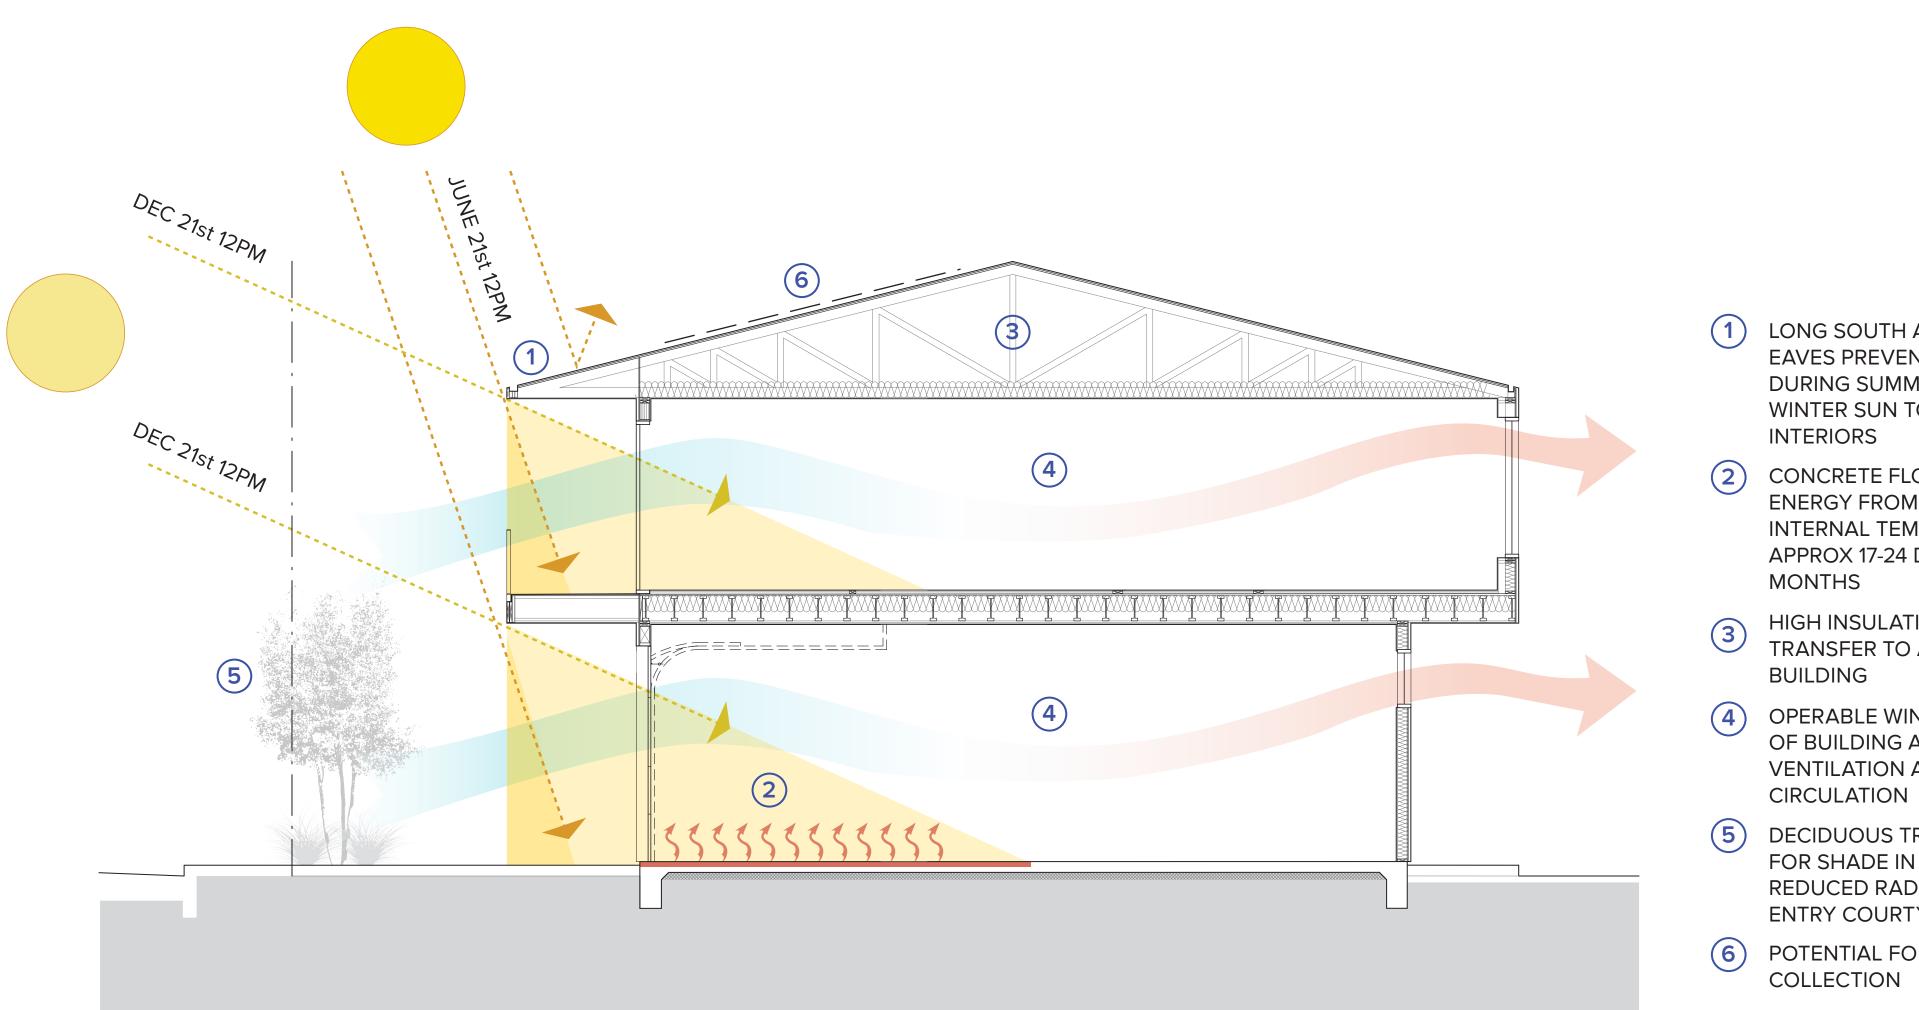
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A810 SUPPLEMENTAL

DIAGRAM: BUILDING MASSING 1 SCALE: NTS





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LONG SOUTH AND WEST FACING EAVES PREVENT OVERHEATING DURING SUMMER / WHILE ALLOWING WINTER SUN TO PENETRATE INTO

CONCRETE FLOORS ABSORB RADIANT ENERGY FROM LOW ANGLED SUN. INTERNAL TEMPARATURES RANGE FROM APPROX 17-24 DEGRESS DURING WINTER

3 HIGH INSULATION VALUES INTERIOR OF HIGH INSULATION VALUES MINIMIZE HEAT

> OPERABLE WINDOWS ON ALL SIDES OF BUILDING ALLOW FOR CROSS VENTILATION AND SUFFICIENT AIR

DECIDUOUS TREE PLANTINGS ALLOW FOR SHADE IN SUMMER MONTHS AND REDUCED RADIANT HEAT GAIN AT PAVED ENTRY COURTYARD

POTENTIAL FOR SOUTH FACING SOLAR

## LOT 13 LANEDA MIXED-USE LOT 13 LANEDA AVE MANZANITA, OR 97130

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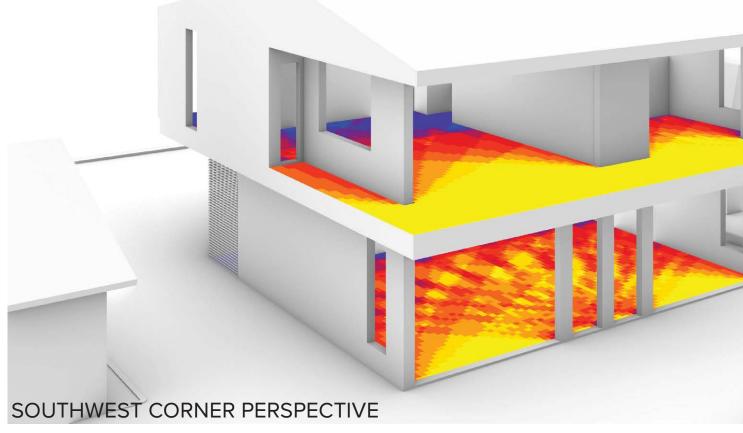
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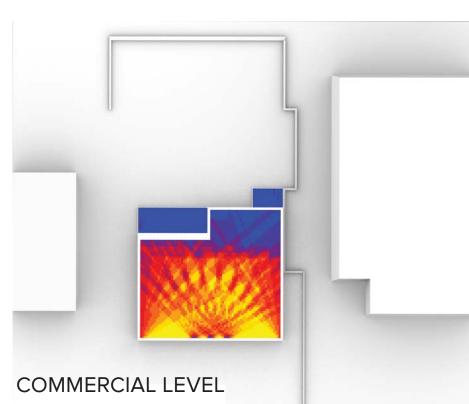
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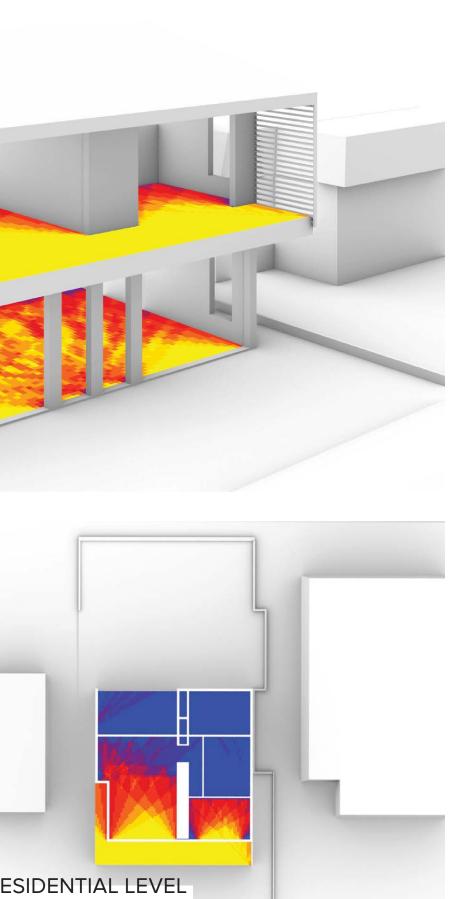
A811

SUPPLEMENTAL

DIAGRAM: PASSIVE DESIGN STRATEGIES 1 SCALE: NTS








RESIDENTIAL LEVEL

TOTAL SUNLIGHT EXPOSURE ON DEC 21

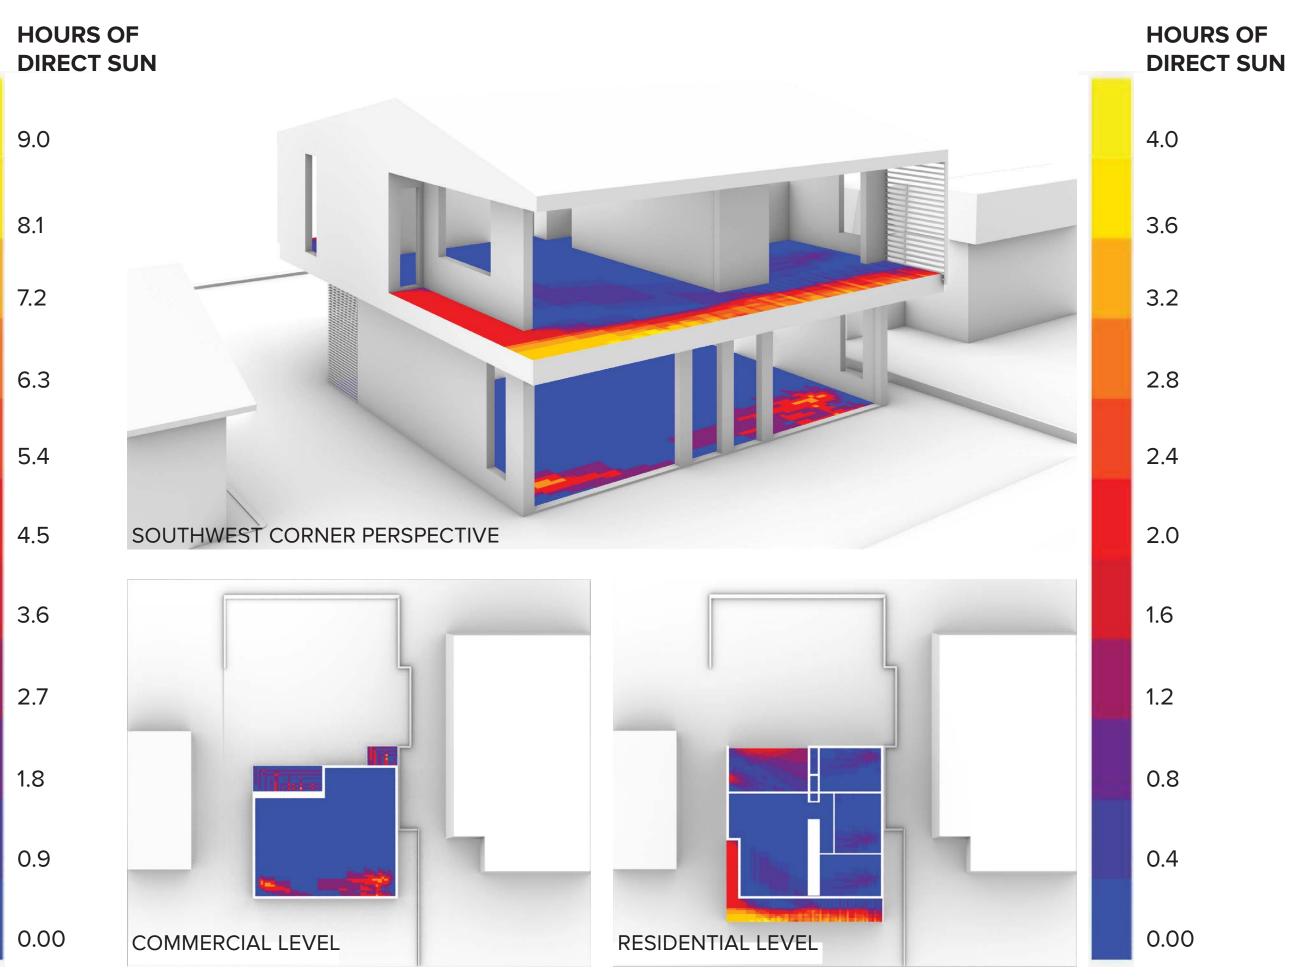

TOTAL SUNLIGHT EXPOSURE ON JUNE 21

LEAD DESIGNER:



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A812 SUPPLEMENTAL

DIAGRAM: SUN EXPOSURE ANALYSIS 1 SCALE: NTS



CONCEPT RENDERING: SW CORNER PERSPECTIVE 1

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CONCEPT RENDERING: NW CORNER PERSPECTIVE 1

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